

- CONSTRUCTION AND THE 1992 STANDARD DETAILS AND SUBSEQUENT ADDENDA FOR PUBLIC WORKS CONSTRUCTION AS ADOPTED BY THE CITY COUNCIL. A DIGITAL COPY OF THE SPECIFICATIONS AND DETAILS IS AVAILABLE AT: HTTP://WWW.SANJOSECA.GOV/INDEX.ASPX?NID=2247

- REQUIRED IN SECTION 21-1.05 OF THE STANDARD SPECIFICATIONS. COMPACT SUBGRADE FOR CURB, GUTTER AND
- ALL ASPHALT CONCRETE MIX SHALL CONFORM TO SECTION 39 OF 2010 CALTRANS STANDARD SPECIFICATIONS AND
- THE 1988 CALTRANS STANDARD SPECIFICATIONS. THE ASPHALTIC EMULSION USED SHALL BE SS-1H. PRIME COAT ALL AGGREGATE BASE SURFACES PRIOR TO PLACING A.C. PAVING UNLESS THE TOTAL THICKNESS OF A.C.
- REQUIRED FOR FULL DEPTH AC ALTERNATE.
- ALL IRRIGATION LINES OR OTHER PRIVATELY OWNED UNDERGROUND LINES THAT REQUIRE RELOCATION AS DETERMINED BY
- CONSTRUCTION PURPOSES IS PROHIBITED. RECYCLED WATER IS AVAILABLE AT MULTIPLE LOCATIONS ACROSS THE CITY CERTIFICATION IS REQUIRED BY SOUTH BAY WATER RECYCLING PRIOR TO RECEIVING A RECYCLED WATER METER. FOR MORE INFORMATION, PLEASE CALL LYLE FROHMAN AT (408) 794-6805.
- - ORDINARILY ENCOUNTERED AND GENERALLY RECOGNIZED AS INHERENT IN WORK OF THE CHARACTER PROVIDED FOR IN NECESSARY, INITIATE FURTHER ANALYSIS OF THE PROBLEM. IF REMEDIATION IS REQUIRED, A REMEDIATION PLAN WILL BE SUBMITTED TO THE DIRECTOR OF PUBLIC WORKS FOR REVIEW BY ENVIRONMENTAL MANAGEMENT AND, UPON APPROVAL BY THE DIRECTOR, BE IMPLEMENTED AT DEVELOPER'S SOLE EXPENSE.
- IN THE EVENT THAT HUMAN REMAINS AND/OR CULTURAL MATERIALS ARE FOUND, ALL PROJECT-RELATED CONSTRUCTION SHOULD CEASE WITHIN A 100-FOOT RADIUS. THE CONTRACTOR SHALL, PURSUANT TO SECTION 7050.5 OF THE HEALTH AND SAFETY CODE, AND SECTION 5097.94 OF THE PUBLIC RESOURCES CODE OF THE STATE OF CALIFORNIA, NOTIFY THE SANTA CLARA COUNTY CORONER IMMEDIATELY.
- CONTRACTOR SHALL PROVIDE VIDEO INSPECTION OF ALL STORM AND SANITARY SEWER MAINS. VIDEO INSPECTION OF ALL MAINS SHALL BE PERFORMED AFTER ALL TESTING HAS BEEN COMPLETED.
- CONTRACTOR SHALL REMOVE ALL U.S.A MARKINGS AS SOON AS THEY ARE NO LONGER NEEDED. ONLY CHALK PAINT SHALL BE USED IN THE REDEVELOPMENT AREA (BOUNDED BY JULIAN STREET AND HIGHWAY 280, AND BETWEEN HIGHWAY 87 AND FOURTH STREET). REMOVAL OF PAINT SHALL BE BY HIGH WATER PRESSURE METHOD ONLY.
- INSTALLATION OR REMOVAL OF STREET TREES REQUIRES A PERMIT FROM THE DEPARTMENT OF TRANSPORTATION. THE CITY ARBORIST WILL SPECIFY SPECIES. CONTACT THE CITY ARBORIST BY EMAIL AT DEVELOPMENTPROJECT@SANJOSECA.GOV WITH YOUR PROJECT INFORMATION TO OBTAIN A TREE PERMIT.
- IF CONTRACTOR DAMAGES EXISTING ASPHALT SECTION DURING THE REMOVAL OF EXISTING CURB AND GUTTER OR AT THE DISCRETION OF THE PROJECT INSPECTOR, THE ASPHALT CONCRETE SHALL BE REPAIRED BY SAWCUTTING 12" MINIMUM FROM THE LIP OF GUTTER AND INSTALLING A 12" MINIMUM 'DEEP-LIFT' AC SECTION.
- CITY SURVEY MONUMENTS SHALL BE PRESERVED. IN THE EVENT THAT A CITY MONUMENT IS LOST TO CONSTRUCTION ACTIVITIES, THE CONTRACTOR SHALL, AT THE CONTRACTOR'S SOLE EXPENSE, BE RESPONSIBLE FOR ITS RE-ESTABLISHMENT AND THE FILING OF A CORNER RECORD WITH THE COUNTY'S SURVEYOR'S OFFICE. A RECORD OF SURVEY SHALL BE FILED FOR ALL NEW CITY MONUMENTS SET IN CONJUNCTION WITH THIS IMPROVEMENT PLAN, UNLESS A FINAL OR PARCEL MAP REQUIRING SAID MONUMENTS IS RECORDED AS PART OF THIS PROJECT.
- PAVEMENT MARKING AND STRIPING LAYOUT AND TRAFFIC SIGNAL LOOP LAYOUT SERVICES SHALL BE PROVIDED BY THE DEVELOPER'S ENGINEER, SURVEYOR, OR OTHER QUALIFIED PERSONNEL.
- PLAN REFERENCES (I.E. PLANNING PERMIT NUMBER, RECORD DRAWINGS, ETC.)

PUBLIC ENCROACHMENT PERMIT FOR THE DOWNTOWN WEST UTILIDOR ON

SAN CARLOS ST, S. MONTGOMERY ST, PARK AVE, W. SAN FERNANDO ST, VTA LIGHT RAIL, CRANDALL ST, CAHILL ST, W. JULIAN ST, RAILROAD CROSSING, AND CINNABAR ST SAN JOSE, CALIFORNIA

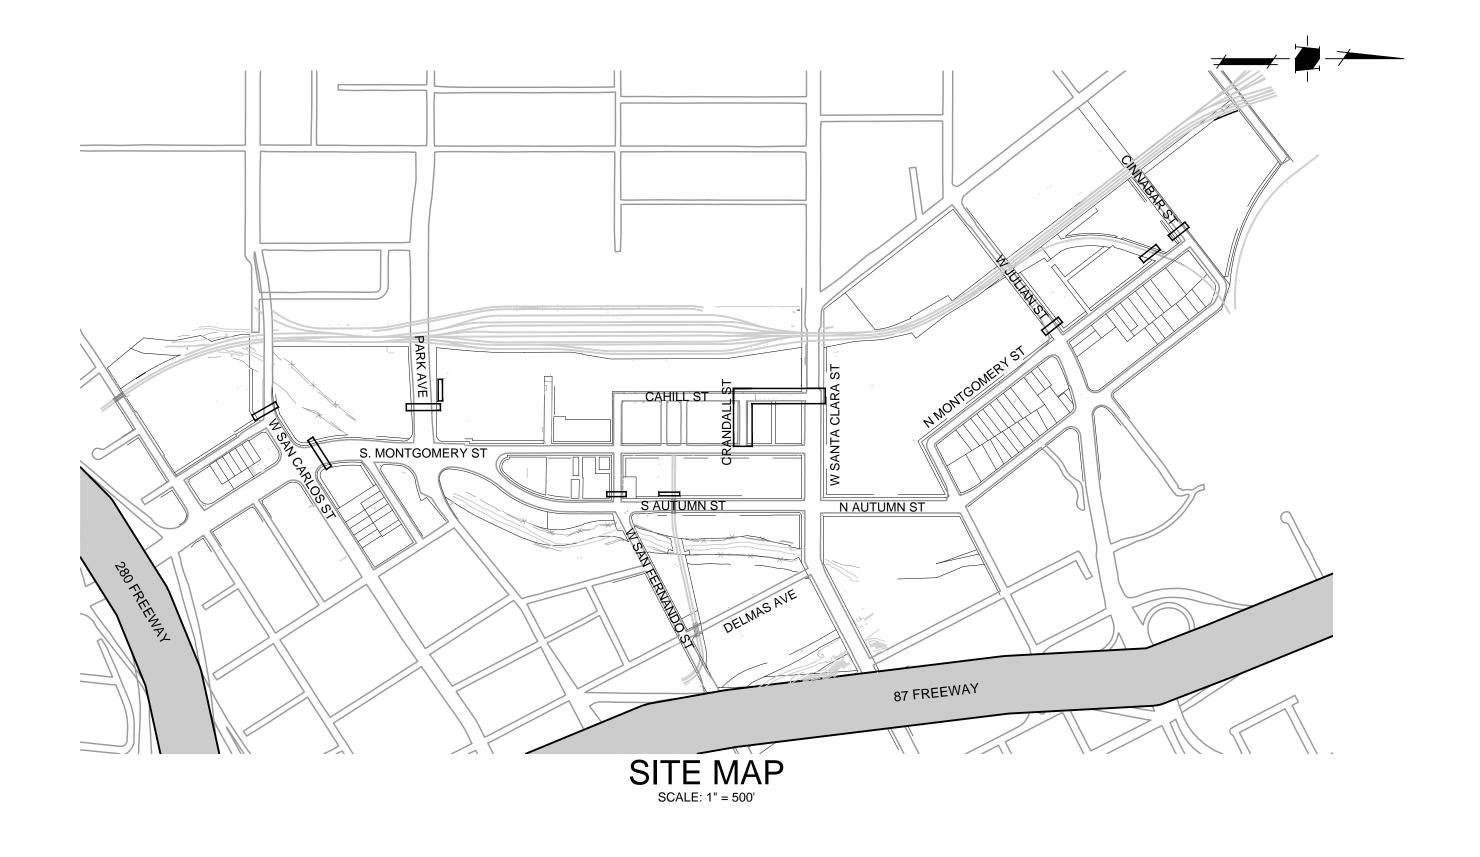

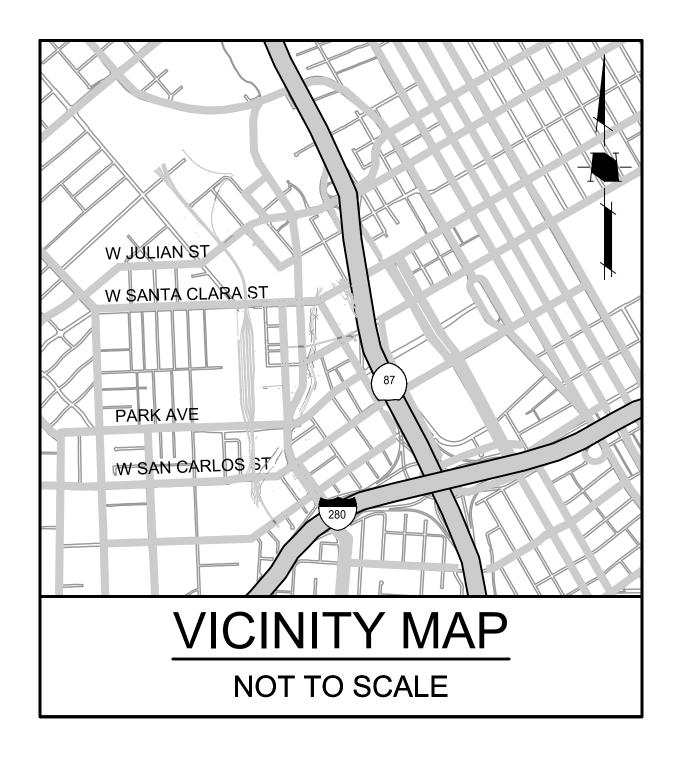

ENGINEER'S STATEMENT

THESE IMPROVEMENT PLANS HAVE BEEN PREPARED BY ME OR UNDER MY DIRECTION IN ACCORDANCE WITH STANDARD



SAN JOSE



PUBLIC ENCROACHMENT PERMIT FOR THE

DOWNTOWN WEST UTILIDOR

PROJECT BASIS OF BEARING

THE CALCULATED BEARING OF SOUTH 02° 43' 35" WEST TAKEN BETWEEN THE RECORD POSTION OF GPS CONTROL POINT 2218 AND GPS CONTROL POINT 1049, AS SHOWN ON THAT CERTAIN RECORD OF SURVEY FILED FOR RECORD ON JUNE 21, 1996, IN BOOK 677 OF MAPS AT PAGE 54, OFFICIAL RECORDS OF SANTA CLARA COUNTY WAS TAKEN AS THE BASIS FOR ALL BEARINGS SHOWN HEREON.

PROJECT BENCHMARK

ELEV DATUM: SCVWD BM365=83.71', NAVD88, DATE ADJUSTED MARCH 14, 2017 VALLEY TRANSPORTATION AGENCY'S ALUMINUM DISK (VTA-225); ON TOP AND AT MID CONCRETE SIDEWALK, 3.1 FEET SOUTH FROM FACE OF CURB, 12 FEET WEST FROM THE SOUTHEAST CORNER OF NEW JULIAN STREET BRIDGE OVER GUADALUPE RIVER BETWEEN HIGHWAY 87 AND AUTUMN STREET, CITY OF SAN JOSE.

SHEET INDEX

SHEET NO. COVER SHEET NOTES, LEGEND, AND ABBREVIATIONS DETAILS PLAN AND PROFILE - WEST SAN CARLOS STREET PLAN AND PROFILE - SOUTH MONTGOMERY STREET PLAN AND PROFILE - PARK AVENUE PLAN AND PROFILE - PARK AVENUE PLAN AND PROFILE - WEST SAN FERNANDO STREET PLAN AND PROFILE - VTA LIGHT RAIL CROSSING PLAN AND PROFILE - CRANDALL STREET PLAN AND PROFILE - CAHILL STREET PLAN AND PROFILE - CAHILL STREET SECTIONS PLAN AND PROFILE - WEST JULIAN STREET PLAN AND PROFILE - RAILROAD CROSSING

PLAN AND PROFILE - CINNABAR STREET

PRELIMINARY NOT FOR CONSTRUCTION

DESIGNED BY CHECKED BY RH 1570 Oakland Road SEPTEMBER 8, 2020 San Jose, CA 95131 HMHca.com DEPARTMENT OF PUBLIC WORKS PERMIT # INSPECTOR: PROJECT# VOICEMAIL: MUNICIPAL WATER CAPITAL OF SILICON VALLEY TREETLIGHT LAYOU APPROVED BY MATTHEW CANO DIRECTOR OF PUBLIC WORKS **ELECTRICAL CIRCUITS**



UNAUTHORIZED CHANGES & USES: THE ENGINEER PREPARING THESE PLANS WILL NOT BE RESPONSIBLE FOR, OR LIABLE FOR, UNAUTHORIZED CHANGES TO OR USES OF THESE PLANS. ALL CHANGES TO THE PLANS MUST BE IN WRITING AND MUST BE APPROVED BY THE PREPARER OF THESE PLANS.

CALIFORNIA

LA/RM/JBC

DRAWN BY:

GENERAL NOTES

THE FOLLOWING NOTES ARE NOT PART OF THE CITY OF SAN JOSE STANDARD NOTES AND ARE PROVIDED AS

- 1. REVISIONS TO THESE PLANS MUST BE REVIEWED AND APPROVED IN WRITING BY HMH AND THE CITY OF SAN JOSE PRIOR TO CONSTRUCTION OF AFFECTED ITEMS.
- 2. THE CONTRACTOR SHALL NOTIFY HMH, AT (408) 487-2200 BEFORE PROCEEDING WITH ANY WORK THAT APPEARS TO BE INSUFFICIENTLY DETAILED.
- 3. CONTRACTOR SHALL REPLACE OR REPAIR, AT CONTRACTOR'S EXPENSE, ALL DAMAGED, REMOVED OR OTHERWISE DISTURBED EXISTING UTILITIES, OR IMPROVEMENTS IN KIND.
- 4. CONTRACTOR SHALL COORDINATE WORK WITH SUBCONTRACTORS, ONGOING GRADING OR SITE WORK OF OTHER CONTRACTORS, AND WITH THE INSTALLATION OF FACILITIES BY PG&E, AT&T AND CABLE TV.
- 5. IF TEMPORARY LANE CLOSURES ARE REQUIRED FOR CONSTRUCTION OPERATIONS, THE CONTRACTOR SHALL PREPARE A TRAFFIC CONTROL PLAN AND OBTAIN APPROVAL FROM THE CITY OF SAN JOSE BEFORE COMMENCING WORK. THE CONTRACTOR SHALL ALSO PROVIDE FLAG MEN, CONES OR BARRICADES, AS NECESSARY TO CONTROL TRAFFIC AND PREVENT HAZARDOUS CONDITIONS, PER CALTRANS STANDARDS.
- 6. EXISTING PEDESTRIAN WALKWAYS, BIKE PATHS AND DISABLED ACCESS PATHWAYS SHALL BE MAINTAINED DURING CONSTRUCTION TO THE SATISFACTION OF THE CITY INSPECTOR.
- 7. CONTRACTOR SHALL BACKFILL TRENCHES, OR PLACE STEEL PLATING AND/OR HOT-MIX ASPHALT, AS REQUIRED BY THE CITY INSPECTOR, TO PROTECT OPEN TRENCHES AT THE END OF EVERY WORK DAY.
- 8. CONTRACTOR SHALL CLEAN STREETS TO REMOVE ACCUMULATION OF MUD AND DEBRIS RESULTING FROM CONSTRUCTION ACTIVITIES.
- 9. THE CONTRACTOR IS RESPONSIBLE FOR CONFORMING TO EXISTING PAVEMENT, ADJACENT LANDSCAPE AND OTHER IMPROVEMENTS WITH A SMOOTH TRANSITION IN PAVING, CURBS, GUTTERS, SIDEWALK, ETC. TO AVOID ABRUPT OR APPARENT CHANGES IN GRADES OR CROSS SLOPES, LOW SPOTS OR HAZARDOUS CONDITIONS.
- 10. CONTRACTOR TO OBTAIN REQUIRED PERMITS FOR HAUL ROUTES PRIOR TO DEMOLITION AND CONSTRUCTION.
- 11. CONTRACTOR IS RESPONSIBLE FOR SCHEDULING ALL INSPECTIONS AS REQUIRED.
- 12. CONTRACTOR IS TO PROVIDE STREET CROSS SLOPES BETWEEN 2% AND 4% UNLESS SPECIFICALLY NOTED OTHERWISE ON PLANS, AND TO ALLOW CITY INSPECTOR AND ENGINEER TO INSPECT FORMS PRIOR TO POURING OF CURB AND GUTTER.
- 13. CONTRACTOR IS TO POTHOLE ALL UTILITY CONNECTIONS PRIOR TO CONSTRUCTION TO VERIFY INFORMATION PROVIDED ON PLAN REGARDING EXISTING UTILITIES.
- 14. IT IS THE CONTRACTOR'S RESPONSIBILITY TO VERIFY THE LOCATIONS OF ALL EXISTING UNDERGROUND UTILITIES. CALL USA (UNDERGROUND SERVICE ALERT) TWO WORKING DAYS BEFORE DIGGING AT (811). LOCATIONS SHOWN ON THE PLANS WERE TAKEN FROM AVAILABLE RECORDS AND ARE APPROXIMATE AND SHOWN FOR GENERAL INFORMATION ONLY, AND MAY BE INCOMPLETE. RELOCATION OR REPAIR OF ANY DAMAGE TO UTILITIES OR PIPELINES AND PLUGGING OR REMOVAL OF ABANDONED LINES SHALL BE THE CONTRACTOR'S RESPONSIBILITY.
- 15. THE LOCATION OF THE MONUMENTS SHOWN ON THIS PLAN ARE FOR GENERAL INFORMATION ONLY. REFER TO THE FINAL MAP FOR THE LOCATION OF EXISTING AND PROPOSED MONUMENTS.
- 16. IT IS THE CONTRACTOR'S RESPONSIBILITY TO MAINTAIN AND PRESERVE THE EXISTING MONUMENTS OF RECORD. SHOULD THE CONTRACTOR DESTROY OR DISTURB ANY MONUMENTS OF RECORD. THE CONTRACTOR SHALL, AT CONTRACTOR'S SOLE EXPENSE, RETAIN A CALIFORNIA LICENSED LAND SURVEYOR TO REPLACE SAID MONUMENTS AND FILE AN APPROPRIATE CORNER RECORD.
- 17. CONTRACTOR SHALL KEEP UP-TO-DATE A COMPLETE RECORD SET OF CONTRACT DRAWINGS SHOWING EVERY CHANGE FROM THE ORIGINAL DRAWINGS MADE DURING THE COURSE OF CONSTRUCTION INCLUDING EXACT LOCATION, SIZES, MATERIALS AND EQUIPMENT. A COMPLETE SET OF CORRECTED AND COMPLETED RECORD DRAWING PRINTS SHALL BE SUBMITTED TO THE ENGINEER PRIOR TO FINAL ACCEPTANCE FOR REVIEW AND APPROVAL BY THE ENGINEER.
- 18. EXTENT OF PAVEMENT SAW CUTTING MAY REQUIRE FIELD ADJUSTMENT DUE TO THE UNEVEN NATURE OF EXISTING PAVEMENTS AND INTERMITTENT NATURE OF DATA COLLECTED FOR DESIGN PURPOSES. CONTACT ENGINEER IF FIELD CONDITIONS DIFFER FROM THOSE ANTICIPATED ON PLAN.

EXISTING CONDITIONS

- EXISTING GRADES AND CONFORM DESIGNS SHOWN ARE BASED OFF OF INTERMITTENT FIELD TOPO DATA AND MAY NOT INCLUDE ALL CONFORM SITUATIONS. CONTRACTOR SHALL REVIEW ALL CONFORM CONDITIONS AND NOTIFY ENGINEER OF ANY AREAS THAT MAY REQUIRE FIELD FIT ADJUSTMENTS. ALL PAVING AND HARDSCAPE CONFORMS MUST COMPLY WITH ADA REQUIREMENTS AND MAINTAIN POSITIVE DRAINAGE TO DRAIN INLETS.
- 2. GRADES ENCOUNTERED ON-SITE MAY VARY FROM THOSE SHOWN. CONTRACTOR SHALL REVIEW THE PLANS AND CONDUCT INVESTIGATIONS AS REQUIRED TO VERIFY EXISTING CONDITIONS AT THE PROJECT SITE.
- . INFORMATION REGARDING EXISTING UTILITIES IS FROM RECORD DATA AND MAY NOT REPRESENT ACTUAL CONDITIONS. CONTRACTOR SHALL CONDUCT FIELD EVALUATION OF ALL EXISTING SUBSURFACE IMPROVEMENTS AND UTILITIES, WHETHER SHOWN ON THESE PLANS OR NOT, PRIOR TO THE COMMENCEMENT OF WORK. CONTRACTOR SHALL CONTACT HMH IF ANY DISCREPANCIES ARE

UTILITIES


- 1. UTILITY BOXES AND LIDS IN PAVED AREAS SHALL BE DESIGNED FOR H-20 LOADING.
- 2. MANHOLES THAT ARE LOCATED IN UNPAVED AREAS SHALL HAVE BOLT DOWN COVERS.
- 3. CONTRACTOR TO COORDINATE THE ADJUSTMENT TO FINISH GRADE OF ALL PG&E, AT&T, CABLE, FIBER OPTIC OR OTHER UTILITY MANHOLES AND VAULTS.
- 4. CONSTRUCTION OF ALL GRAVITY FLOWING UTILITIES SHALL PROCEED FROM THE DOWNSTREAM CONNECTION TO THE UPSTREAM CONNECTION. THIS WILL ALLOW FOR ANY NECESSARY ADJUSTMENTS TO BE MADE PRIOR TO THE INSTALLATION OF THE ENTIRE LINE. IF THE CONTRACTOR FAILS TO BEGIN AT THE DOWNSTREAM CONNECTION POINT AND WORK UPSTREAM, CONTRACTOR SHALL PROCEED AT CONTRACTOR'S OWN RISK AND BE RESPONSIBLE FOR ANY ADJUSTMENTS NECESSARY.
- PROPOSED WATER SYSTEM SHOWN ON CIVIL PLANS IS GRAPHICAL AND FOR COORDINATION PURPOSES ONLY. SEE PLANS BY OTHERS.
- 6. PROPOSED ELECTRIC, GAS, TELEPHONE, CABLE AND JOINT TRENCH INFORMATION SHOWN ON CIVIL PLANS IS GRAPHICAL AND FOR COORDINATION PURPOSES ONLY. SEE JOINT TRENCH PLANS.

STATEMENT OF RESPONSIBILITY

CONTRACTOR SHALL ASSUME SOLE AND COMPLETE RESPONSIBILITY FOR JOB SITE CONDITIONS DURING THE COURSE OF CONSTRUCTION OF THIS PROJECT, INCLUDING SAFETY OF ALL PERSONS AND PROPERTY. THIS REQUIREMENT SHALL APPLY CONTINUOUSLY AND NOT BE LIMITED TO NORMAL WORKING HOURS. THE CONTRACTOR SHALL DEFEND, INDEMNIFY AND HOLD THE OWNER AND THE ENGINEER HARMLESS FROM ANY AND ALL LIABILITY, REAL OR ALLEGED, IN CONNECTION WITH THE PERFORMANCE OR WORK ON THIS PROJECT, EXCEPTING FOR LIABILITY ARISING FROM THE SOLE NEGLIGENCE OF THE OWNER OR THE ENGINEER.

1-110	
1570 Oakland Road	(408) 487-2200
San Jose, CA 95131	HMHca.com

DATE:	SEPTEMBER 8, 2020
SCALE:	NTS
DESIGNED:	RH
DRAWN:	LA/RM/JBC
CHECKED:	RH
PROJ. ENGR:	RH
FILE:	571900IP.DWG

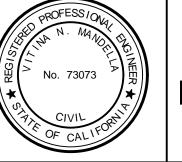

PRELIMINARY NOT FOR CONSTRUCTION

FOR THE IMPROVEMENT OF THE DOWNTOWN WEST UTIL NOTES, LEGEND, AND **ABBREVIATIONS**

SAN JOSE

	PROJE
LIDOR D	PROJECT INSPECTOR VOICEMAIL
CALIFORNIA	

LEGEND

PROPERTY LINE

RIGHT OF WAY EASEMENT

SIDEWALK

CENTERLINE

CURB AND GUTTER

STREET MONUMENT

SANITARY SEWER

SANITARY LATERAL

STORM DRAIN LINE

WHEELCHAIR RAMP

AC PAVEMENT OVERLAY

AC PAVEMENT GRIND

SAWCUT LINE

WATER MAIN

WATER VALVE

RECLAIMED WATER

FIRE HYDRANTS

STREET SIGN

ELECTROLIER

UTILITY POLE

STREET LIGHT

PULL BOX

OVERHEAD

COMCAST

FIBER OPTIC

ELECTRICAL

THERMAL PIPE

GAS

AT&T

DETAIL CALLOUT

AC DEEP LIFT (AC PLUG)

WATER SERVICE AND METER

DRIVEWAY

TREE

STORM DRAIN MANHOLE

STORM DRAIN CURB INLET

STORM DRAIN FIELD INLET

SANITARY SEWER MANHOLE

SANITARY SEWER CLEAN OUT

PROJECT BOUNDARY

PROPOSED

-----RW-----

_____FO____

AUTOMATED WASTE COLLECTION SYSTEM — — — —

A ——DETAIL

3 /---SHEET NUMBER

MIT # JECT #	PROJECT ENGINEER		DEPARTMENT OF TRANSPORTATION - OPS	
JLC1#	NAME	DATE	NAME	DATE
T TOR:	DEPARTMENT OF TRANSPORTATION		STREETLIGHT LAYOUT	
AIL:	NAME	DATE	NAME	DATE
	MUNICIPAL WATER		ELECTRICAL CIRCUITS	
	NAME	DATE	NAME	DATE

EXISTING	ABB	ABBREVIATIONS		
	@	AT		
	ABN	ABANDONED		
	AC ANG PT	ASPHALTIC CONCRETE ANGLE POINT		
	ARV	AIR RELEASE VALVE		
	AWCS	AUTOMATED WASTE COLLECTION SYSTEM		
	BC BOA	BEGIN CURVE BLOW OFF ASSEMBLY		
	BOW	BACK OF WALK		
	BW	BOTTOM OF WALL		
0	CL/Q	CENTER LINE		
	CSJ DIP	CITY OF SAN JOSE DETAIL DUCTILE IRON PIPE		
SS(E)	DW	DRIVEWAY		
	EC	END CURVE		
	ELEC EL/ELEV	ELECTRIC ELEVATION		
	EP	EDGE OF PAVEMENT		
0	ER	END OF RETURN		
——————————————————————————————————————	ESMT	EASEMENT EXISTING		
\odot	EX/(E) FG	FINISHED GRADE		
	FH	FIRE HYDRANT		
\triangle	FL FOO/FO	FLOW LINE		
	FOC/FC G	FACE OF CURB GAS		
	GB	GRADE BREAK		
∠	HORIZ	HORIZONTAL		
	HP INV	HIGH POINT INVERT		
	IRR	IRRIGATION		
	JT	JOINT TRENCH		
	LP LT DT	LOW POINT		
(•)	LT, RT MUTCD	LEFT, RIGHT CALIFORNIA MANUAL ON UNIFORM TRAFFIC CONTROL DEVICES		
	MIN	MINIMUM		
	NTS	NOT TO SCALE		
	PCC Pl	POINT OF COMPOUND CURVATURE POINT OF INTERSECTION		
	P_/ PL	PROPERTY LINE		
	POC	POINT ON CURVE		
	PRC PSE	POINT OF REVERSE CURVE PUBLIC SERVICE EASEMENT		
	PUE	PUBLIC UTILITY EASEMENT		
	PVMT	PAVEMENT		
W/E)	RAD/R (R)	RADIUS REMOVE		
W(E)	RCP	REINFORCED CONCRETE PIPE		
\bowtie	RCW	RECLAIMED WATER		
W(E)	R/W S	RIGHT OF WAY SLOPE		
	SD	STORM DRAIN		
Q	SDCB	STORM DRAIN CATCH BASIN		
	SDCI	STORM DRAIN CURB INLET		
þ	SDFI SDJB	STORM DRAIN FIELD INLET STORM DRAIN JUNCTION BOX		
\bigcirc	SDMH	STORM DRAIN MANHOLE		
-0-	SL	STREET LIGHT		
	SS SSCO	SANITARY SEWER SANITARY SEWER CLEANOUT		
	SSFI	SANITARY SEWER FLUSHING INLET		
	SSFM	SANITARY SEWER FORCE MAIN		
————G(E)———	SSMH STA	SANITARY SEWER MANHOLE STATION		
———OH(E)———	STD	STANDARD		
————AT&T(E)———	SW	SIDEWALK		
COMCAST(E)	TBD TBV	TO BE DETERMINED TO BE VERIFIED		
, ,	TC	TOP OF CURB		
———FO(E) ———	TDC	TOP OF DEPRESSED CURB		
————E(E)———	TP TRC	THERMAL PIPE TOP OF ROLLED CURB		
	TVC	TOP OF ROLLED CORB TOP OF VERTICAL CURB		
	TW	TOP OF WALL		
	VERT	VERTICAL		
	VCP W	VITRIFIED CLAY PIPE WATER		
	\\/\\	WATED METED		

WATER METER

WATER VALVE

WM

APPROVED BY MATTHEW CANO


DIRECTOR OF PUBLIC WORKS

SHEET 2 OF 15

DEPARTMENT OF PUBLIC WORKS

PIPE SIZE	LIMITS OF X			
FIFE SIZE	MINIMUM	MAXIMUM		
24" OR LESS	4"	4" + O.D.		
27" AND GREATER	6"	6" + <u>O.D.</u>		

CATEGORY OF PIPE
VITRIFIED CLAY PIPE, CONCRETE PIPE 25" DIA. AND GREATER
CONCRETE PIPE 24" DIA. AND LESS
DUCTILE IRON PIPE

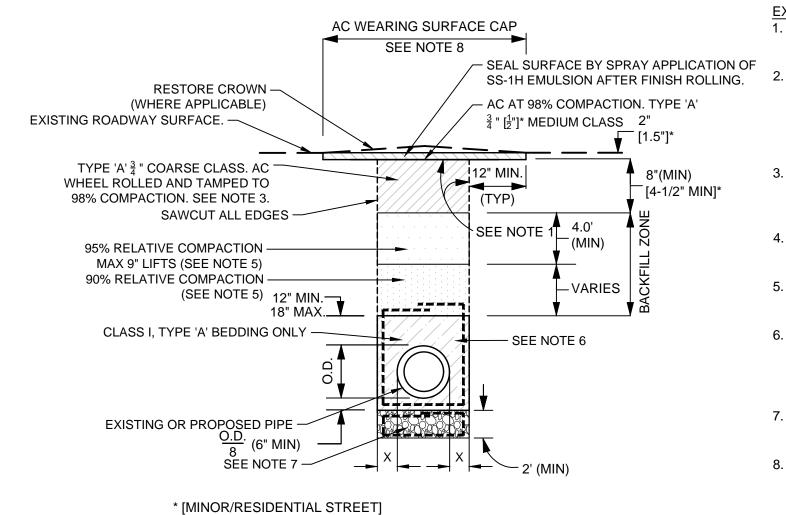

EXISTING STREET TRENCH NOTES:

CLEAN AND TACK COAT ON BOTH SIDES OF EXCAVATED TRENCH
 & BETWEEN AC COURSES WITH SPRAY APPLICATION OF SS-1H
 BINDER BEFORE PLACING AC SURFACE.

2. PLACE A TOTAL OF 10" OR EXISTING +3" AC BASE TO FINISH GRADE, WHICHEVER THICKNESS IS GREATER. AC BASE SHALL BE PLACED IN A MINIMUM OF 2 LIFTS. GRIND ENTIRE WEARING SURFACE CAP WIDTH INCLUDING AC BASE AND EXISTING SURFACE TO DEPTH OF 2" [1.5"]* BELOW FINISH GRADE JUST PRIOR TO PLACING AC SURFACE.

3. 2" [1.5"]* SURFACE CAP SHALL BE PLACED THE SAME DAY AS THE PAVEMENT GRINDING, OR COVERED WITH NON-SKID STEEL PLATES COUNTERSUNK FLUSH WITH THE ADJACENT GRADES UNTIL THE AC SURFACE CAN BE PLACED.

4. SHOVEL - SLICING OF BEDDING MATERIAL IN THE HAUNCH AREAS IS REQUIRED WHEN BEDDING IS NO HIGHER THAN THE QUARTER POINT OF THE PIPE.
5. THE CONTRACTOR SHALL USE CLASS III AGGREGATE BASE, 3/4"

MAXIMUM GRADATION AS BACKFILL MATERIAL AND SHALL CONFORM TO SECTION 26 OF THE STANDARD SPECIFICATIONS.


6. GEOTEXTILE TO BE PLACED BETWEEN CLASS III AB AND BEDDING IF THE NATIVE SOIL SURROUNDING THE TRENCH IS FOUND TO BE HEAVY CLAY. FOR ALL OTHER NATIVE SOIL CONDITIONS THE GEOTEXTILE SHALL BE WRAPPED AROUND THE ENTIRE TRENCH

AS SHOWN.

7. GEOTEXTILE AND CLASS I, BEDDING STABILIZATION MATERIAL SHALL BE USED FOR UNSUITABLE SOIL CONDITIONS ONLY OR AS DIRECTED BY CITY ENGINEER/INSPECTOR.

8. WIDTH OF FINAL AC WEARING CAP SHALL BE 6FT MINIMUM OR THE TRENCH WIDTH PLUS 2 FT MIN, WHICHEVER IS GREATER.

2 CSJ EXISTING STREET TRENCH RESTORATION

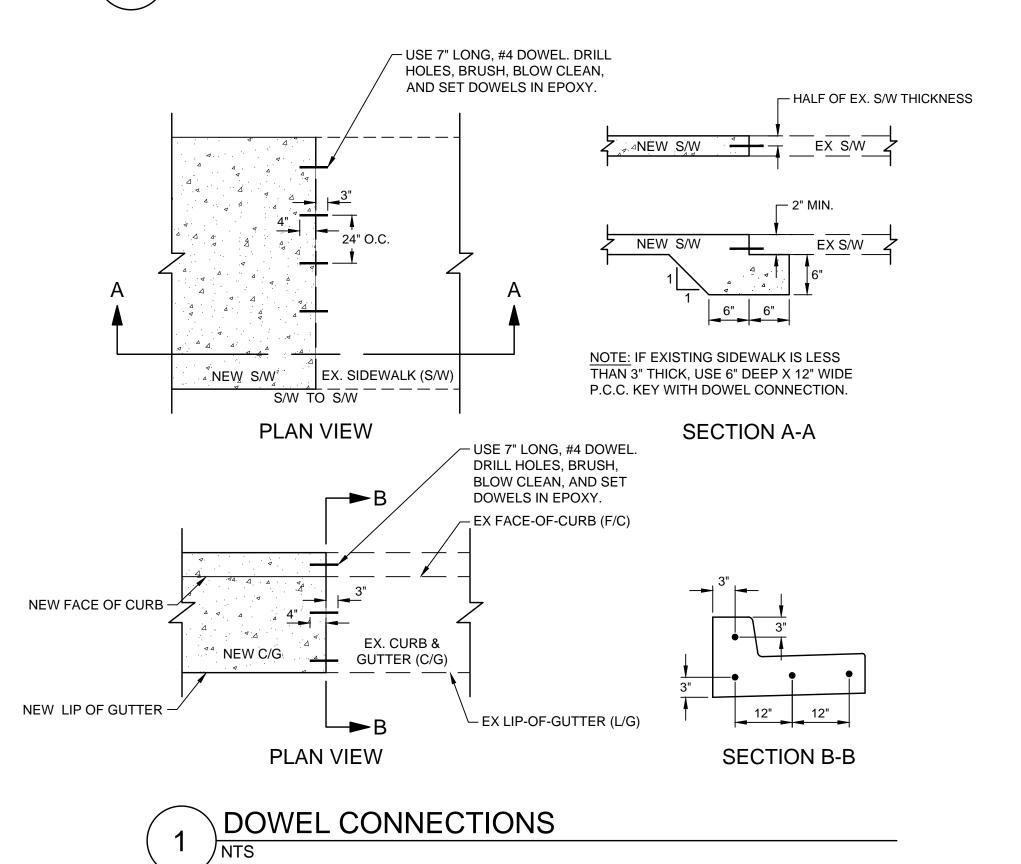



DATE:	SEPTEMBER 8, 2020	
SCALE:	NTS	
DESIGNED:	RH	1
DRAWN:	LA/RM/JBC	
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PROJ. ENGR:	RH	
FILE:	571900IP.DWG	



PRELIMINARY
NOT FOR CONSTRUCTION

FOR THE IMPROVEMENT OF THE

DOWNTOWN WEST UTILIDOR

DETAILS

CALIFORNIA

SAN JOSE

PERMIT #
PROJECT #

PROJECT ENGINEER

NAME

PROJECT ENGINEER

NAME

DEPARTMENT OF TRANSPORTATION

NAME

MUNICIPAL WATER

DATE	
DATE	CITY OF
	SAN
DATE	CAPITAL OF SILIO

DEPARTMENT OF TRANSPORTATION - OPS

STREETLIGHT LAYOUT

ELECTRICAL CIRCUITS


DATE


DEPARTMENT OF PUBLIC WORKS


APPROVED BY MATTHEW CANO DIRECTOR OF PUBLIC WORKS


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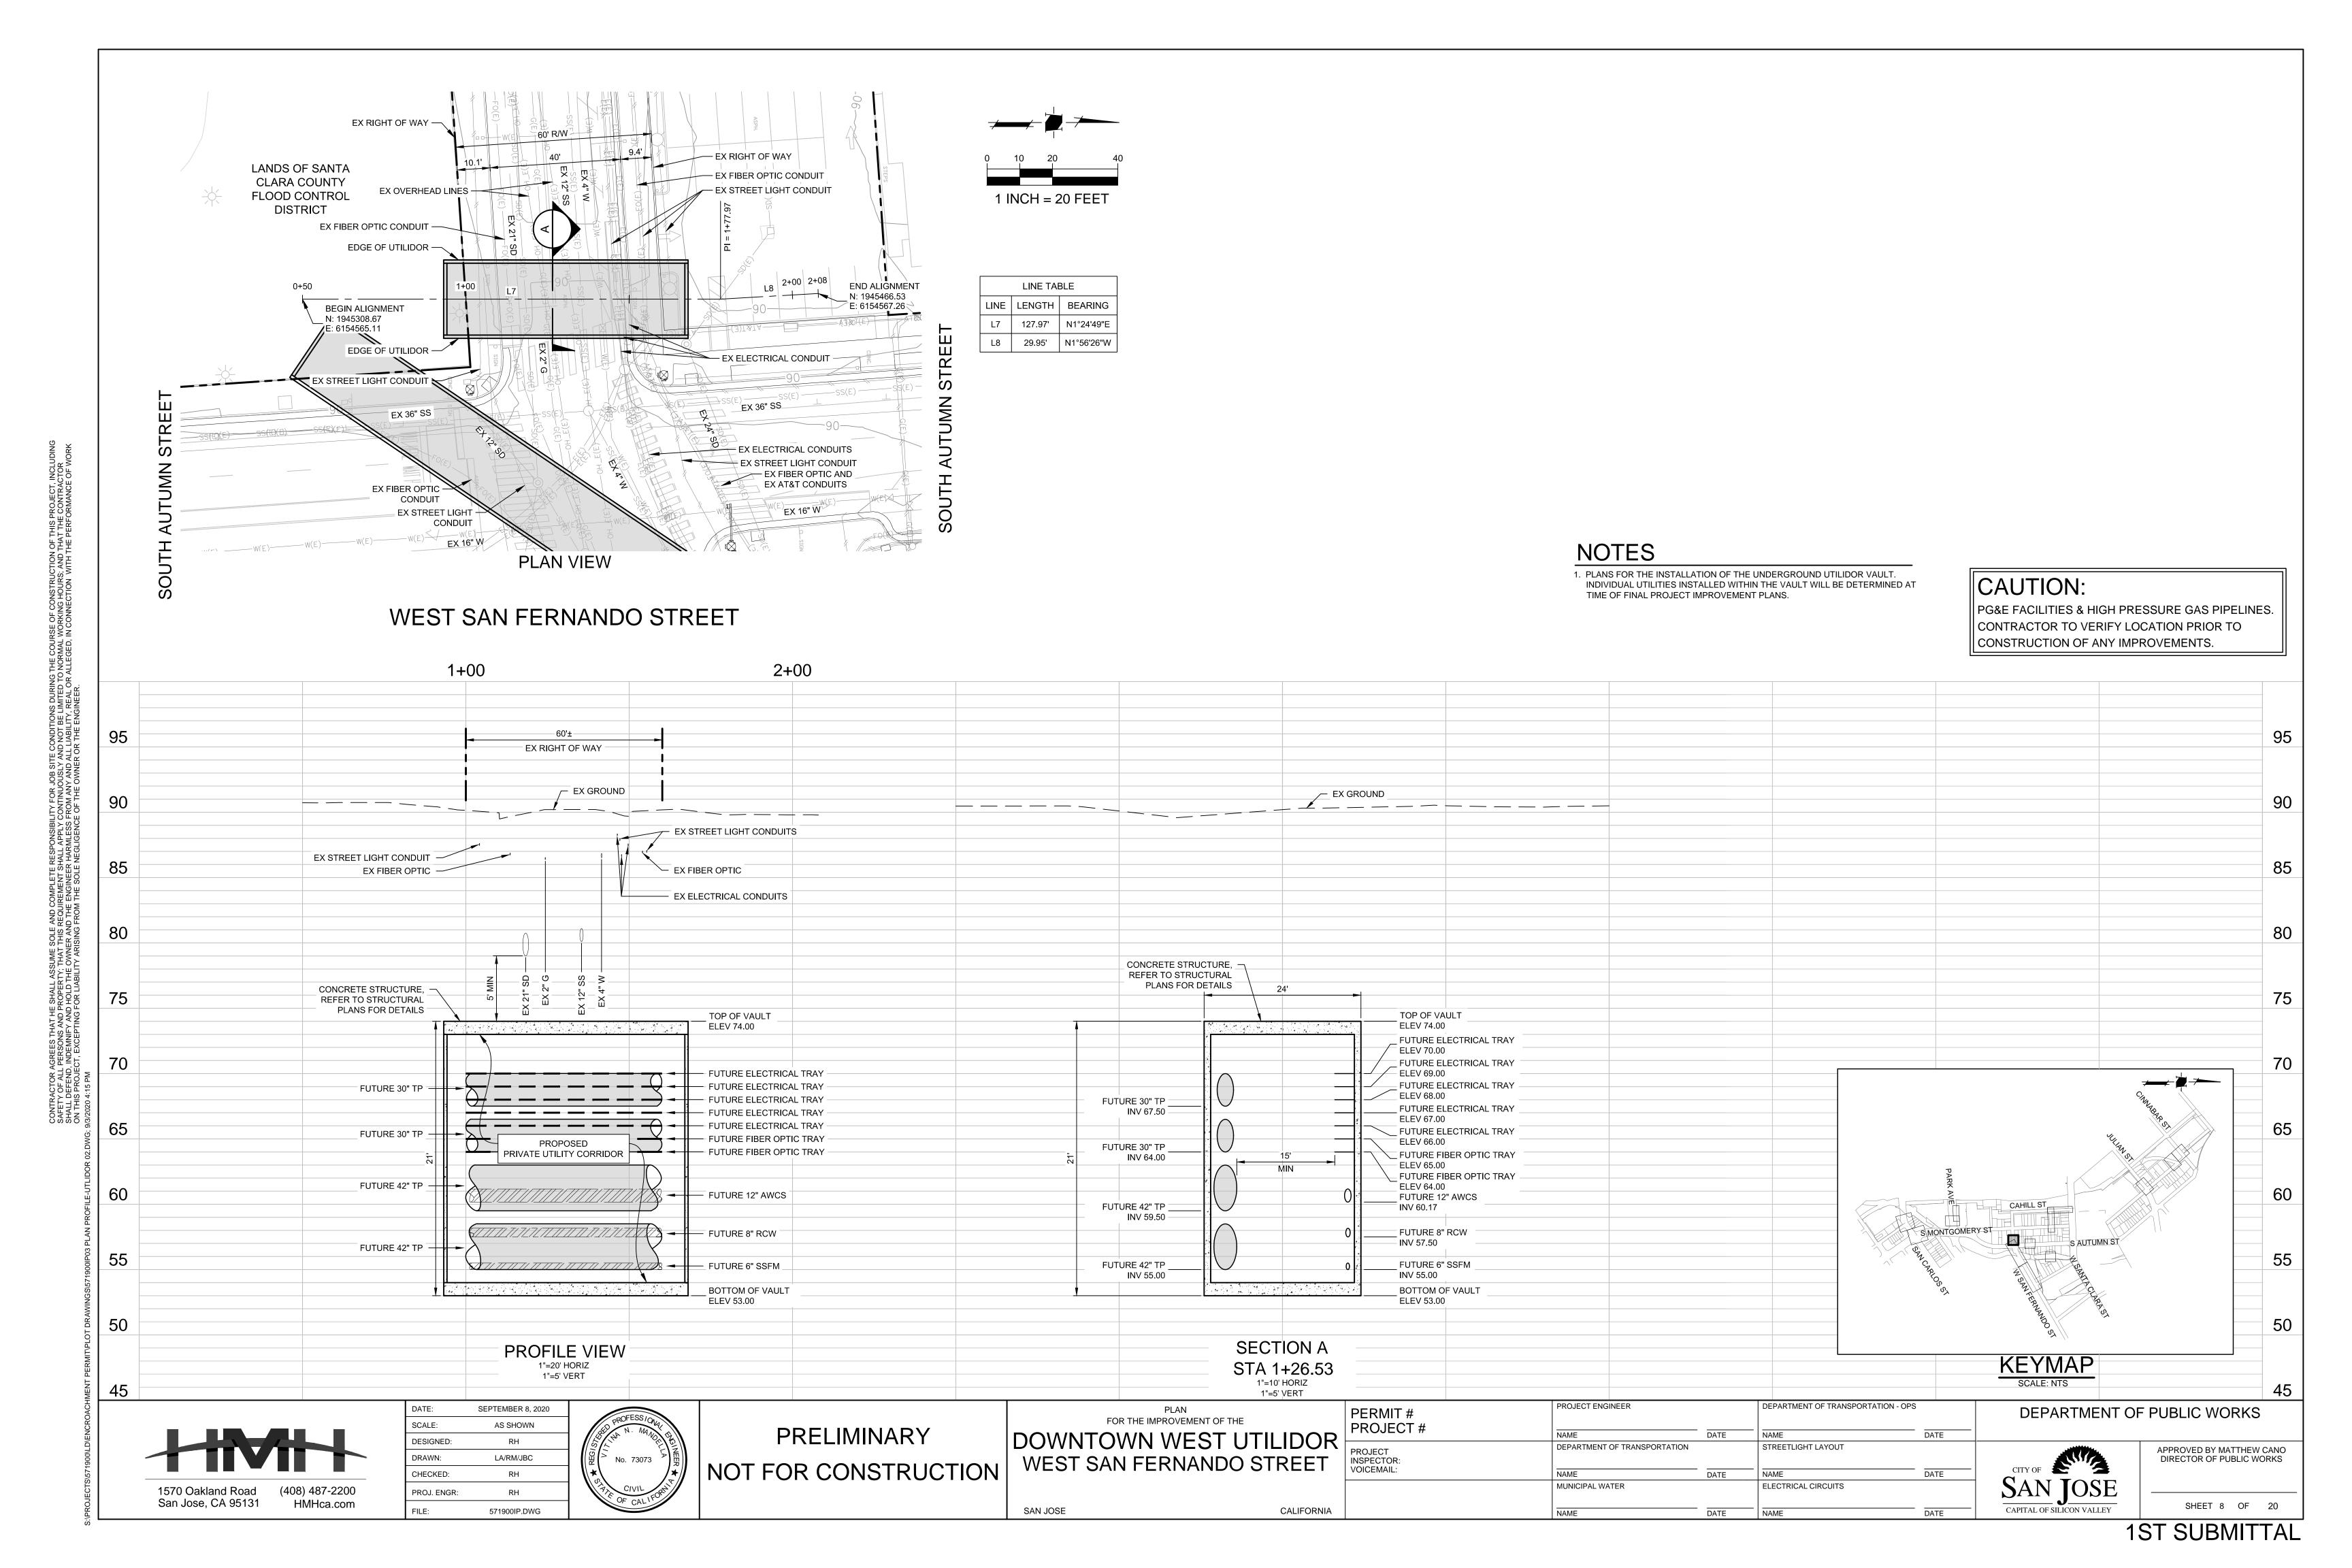
SHEET 3 OF 15




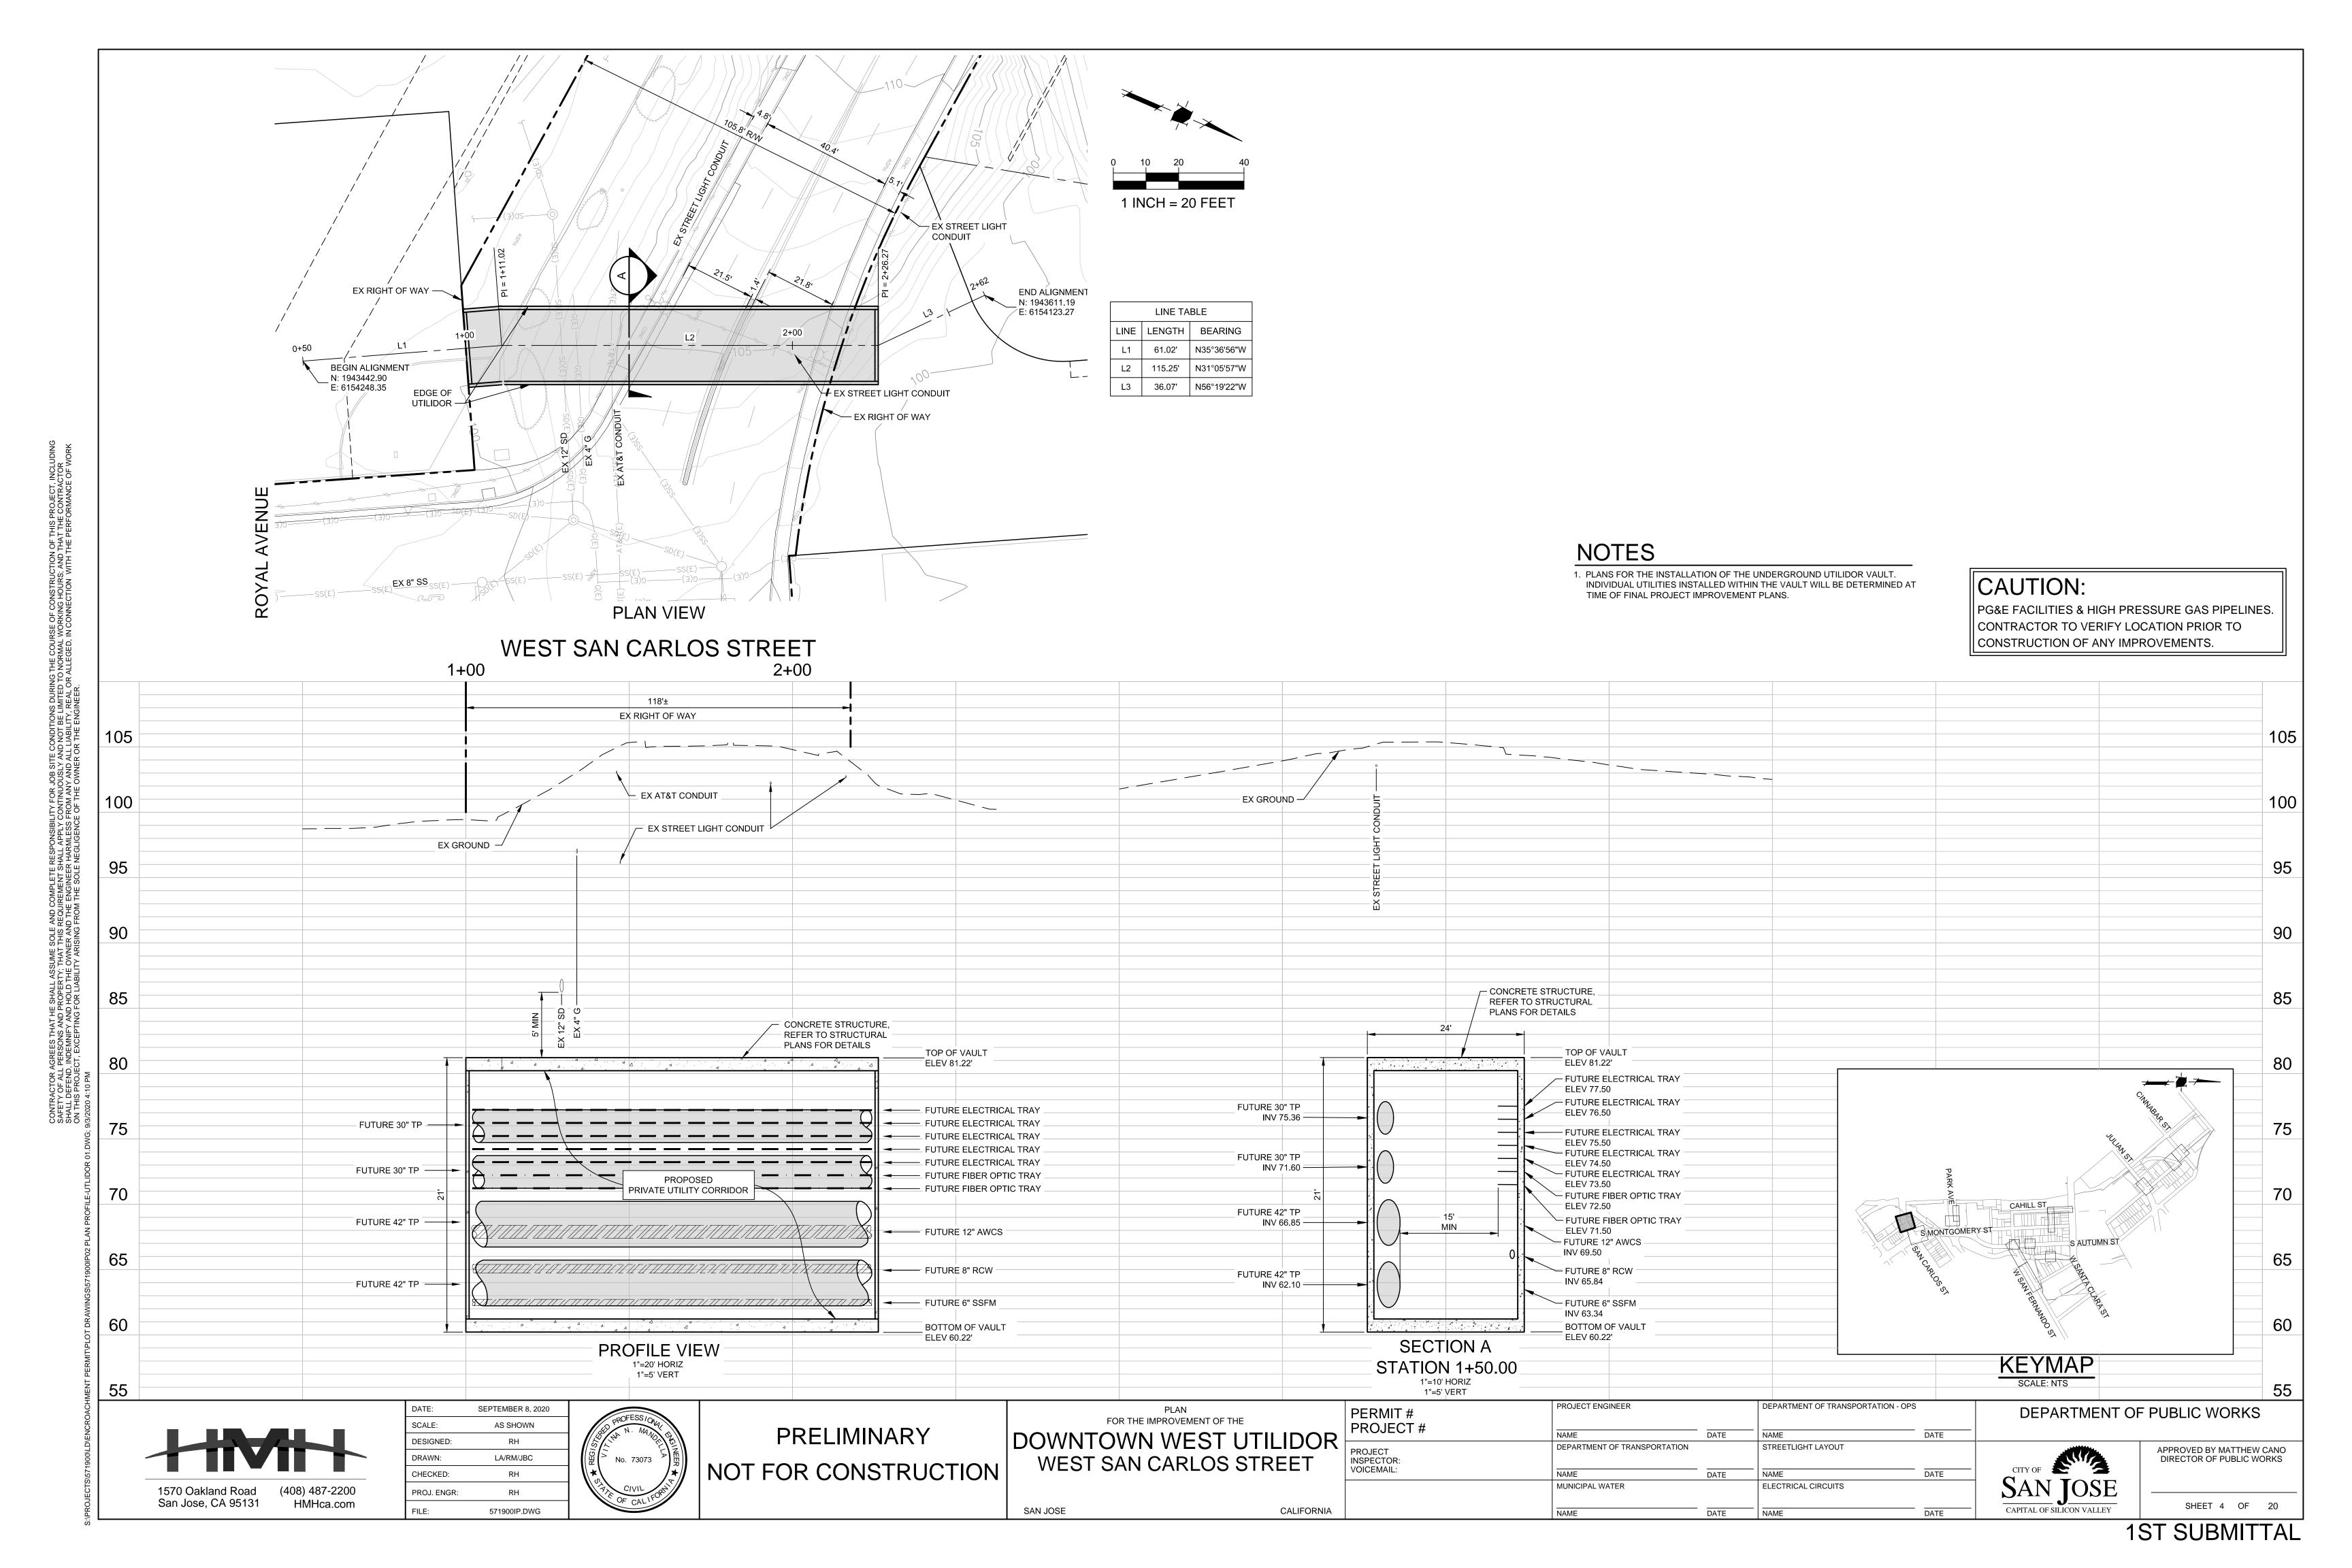


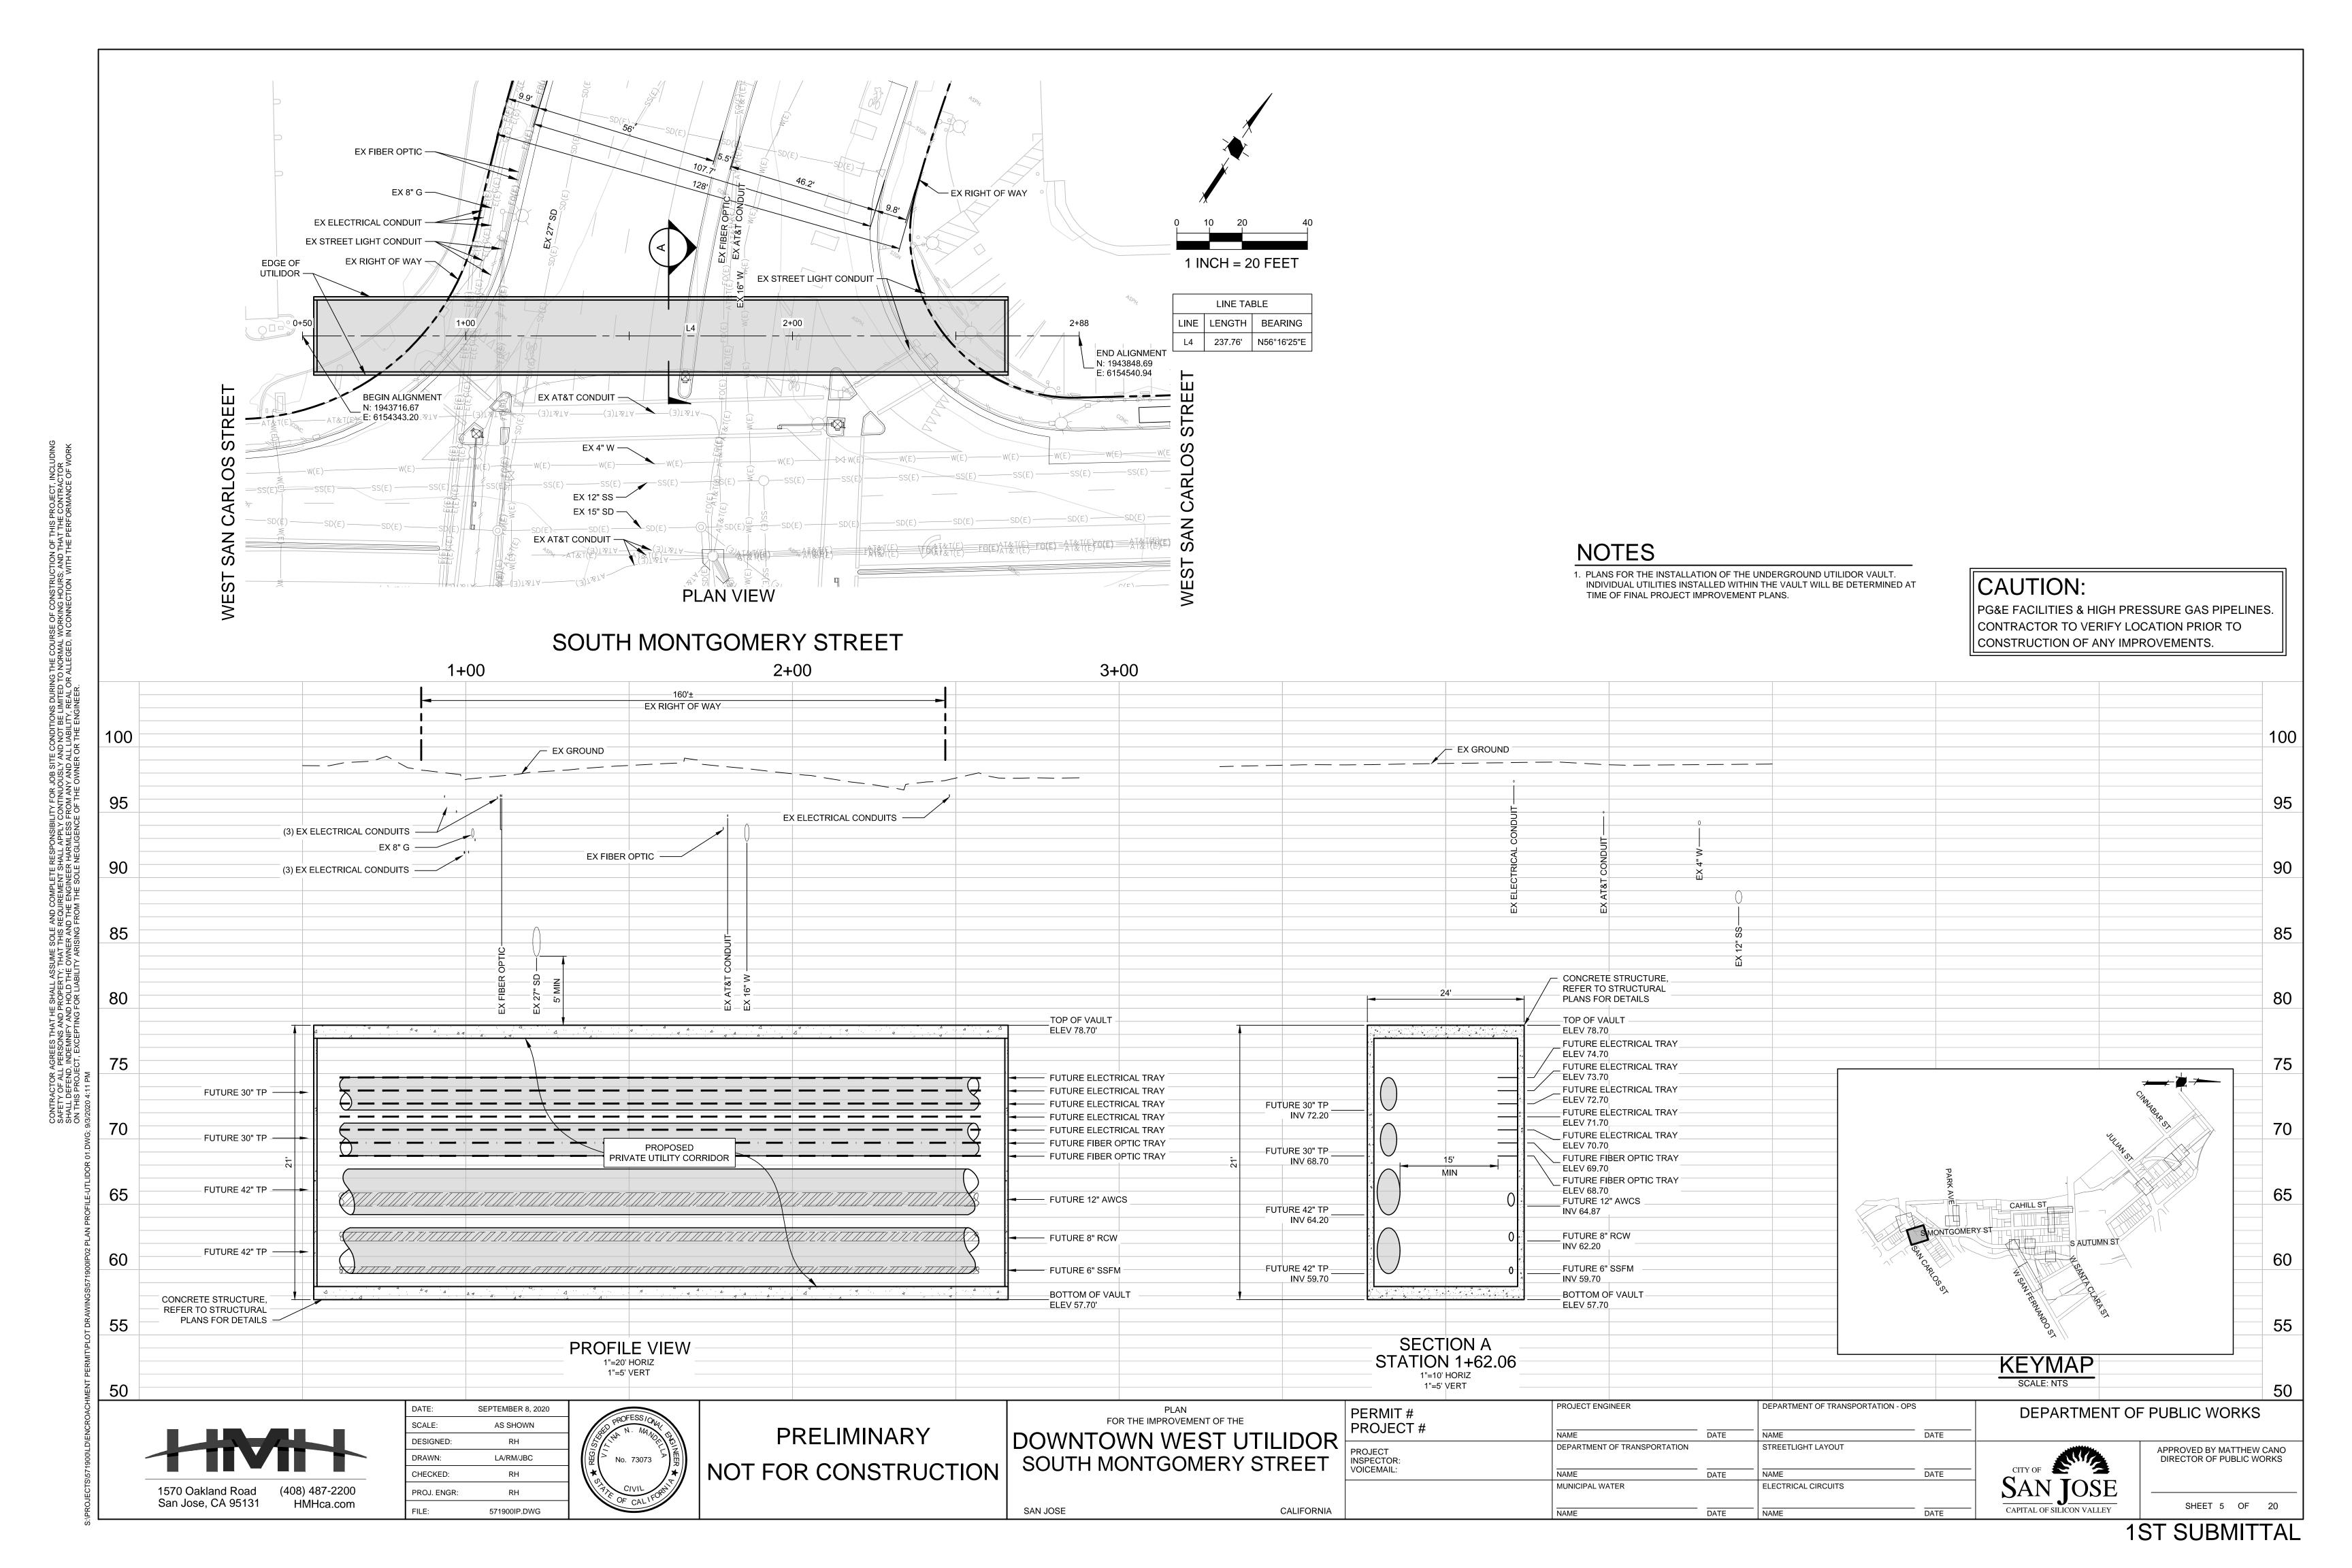


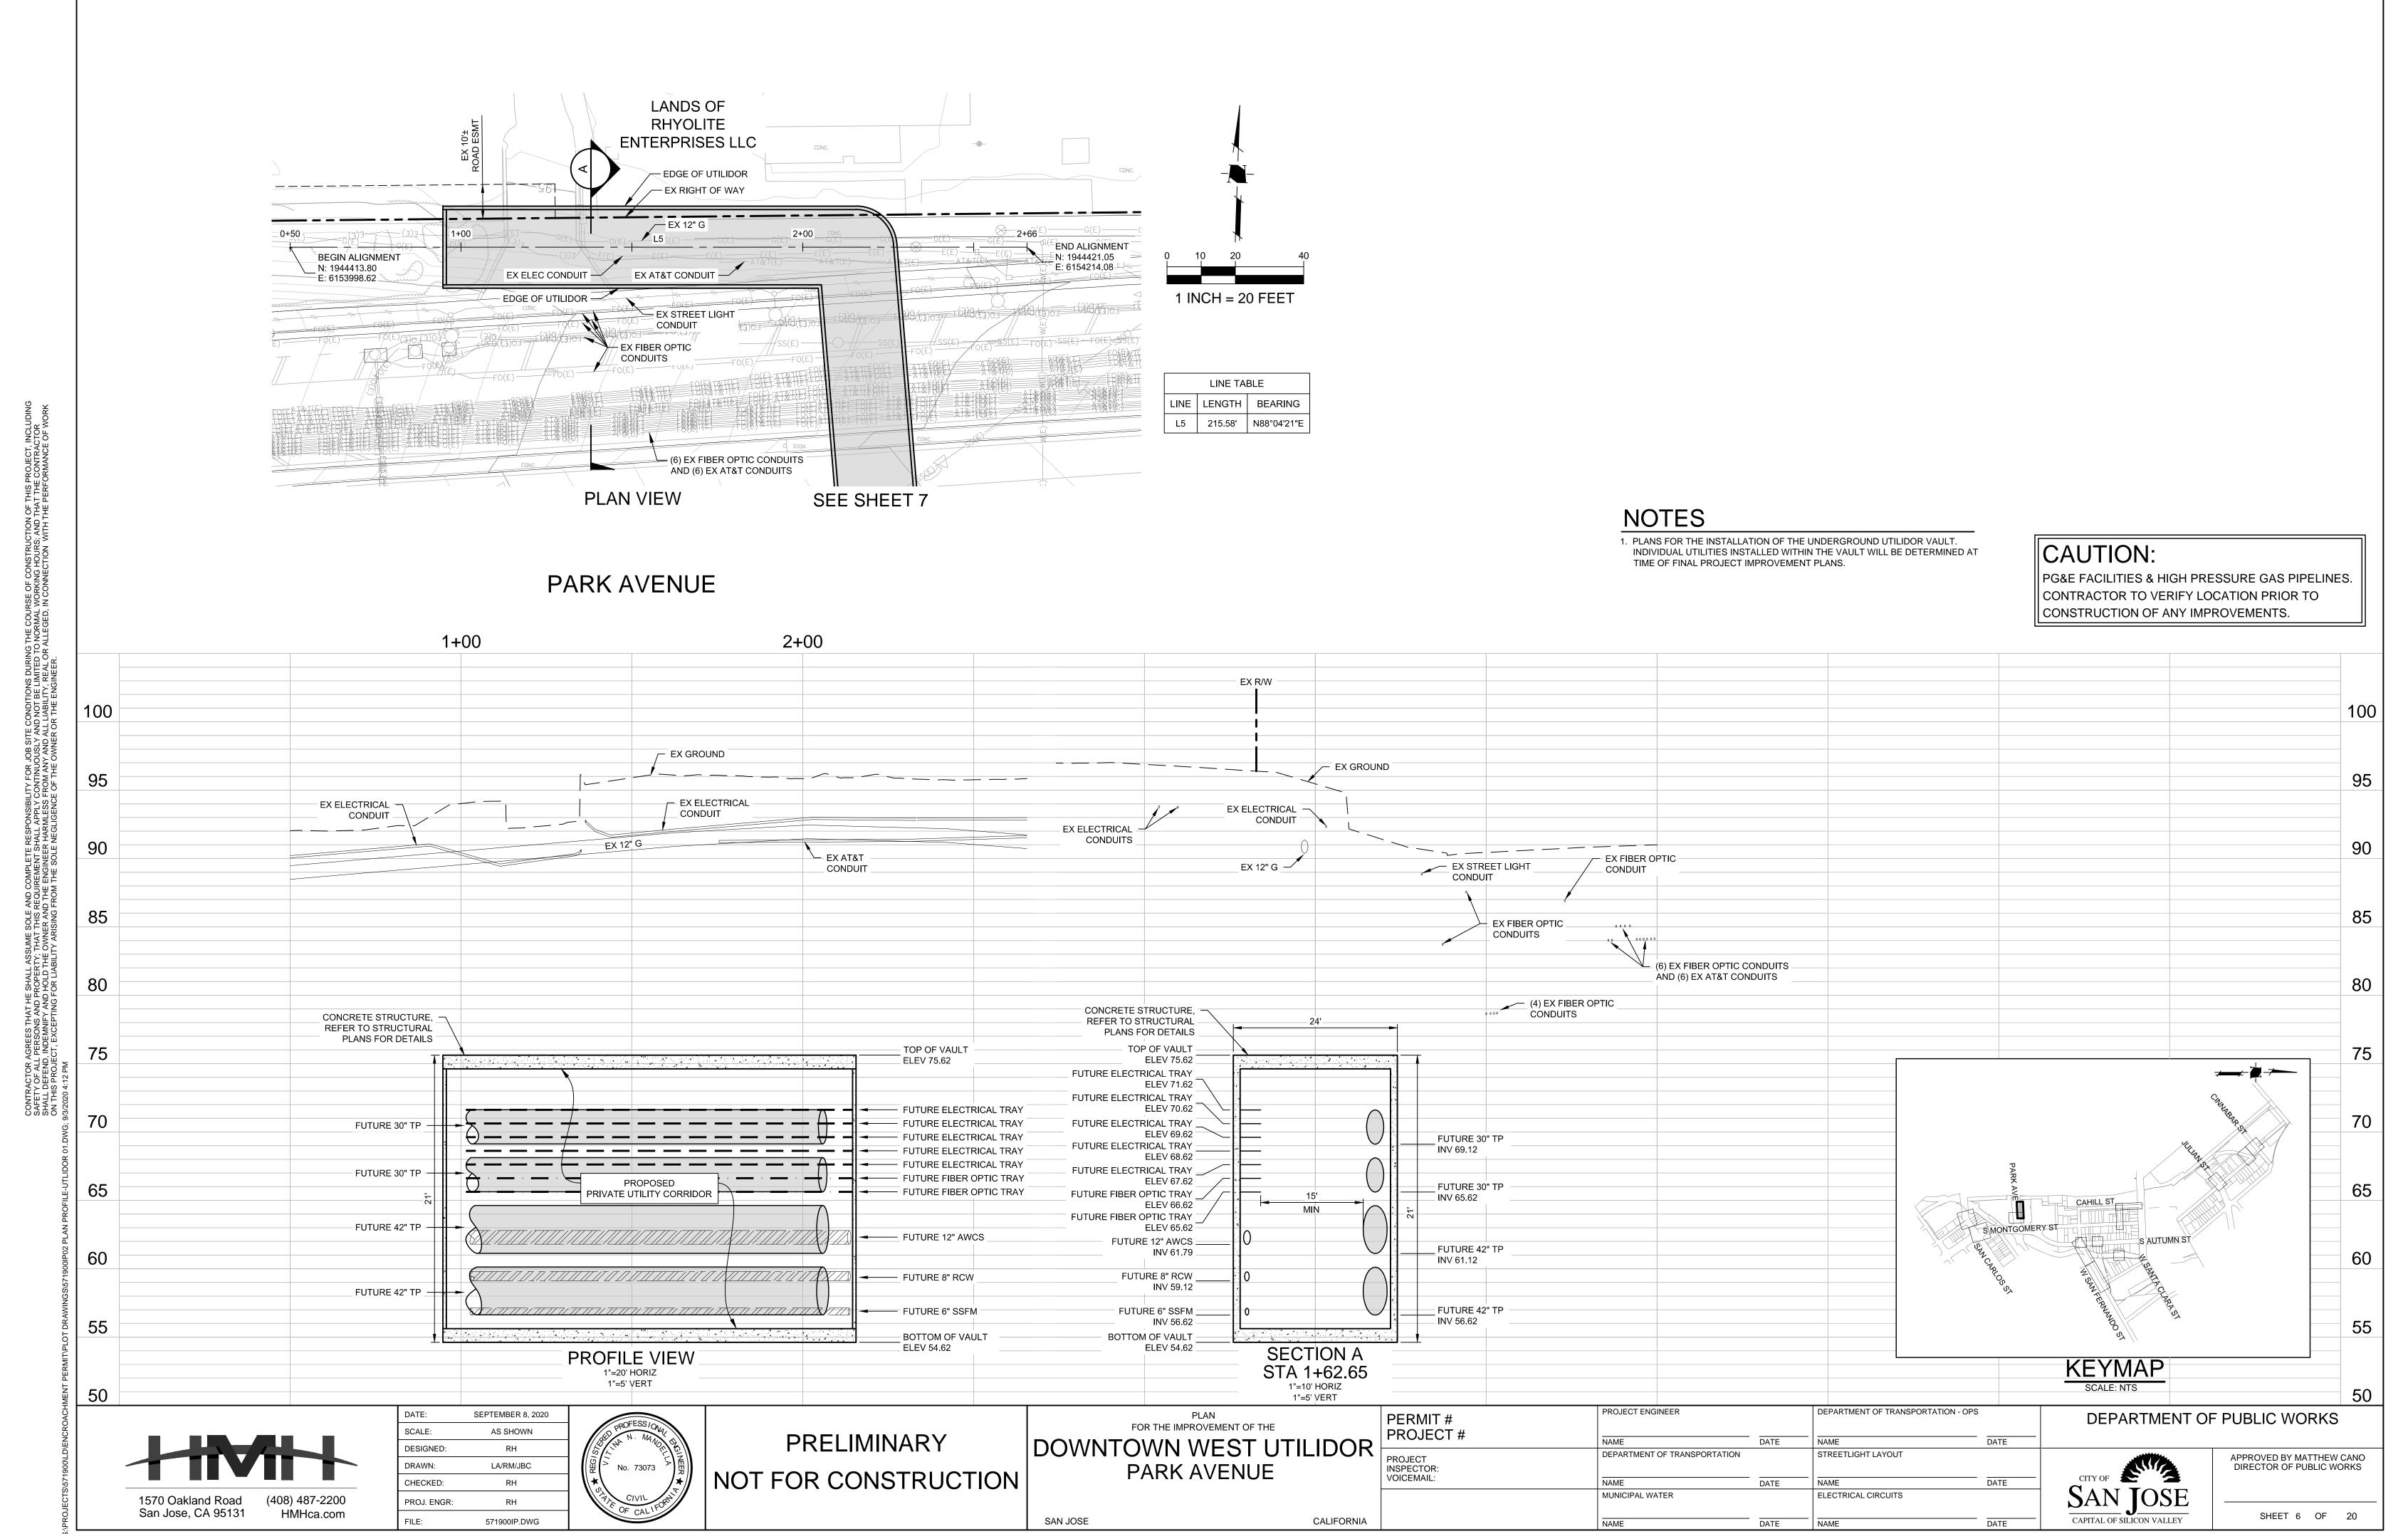

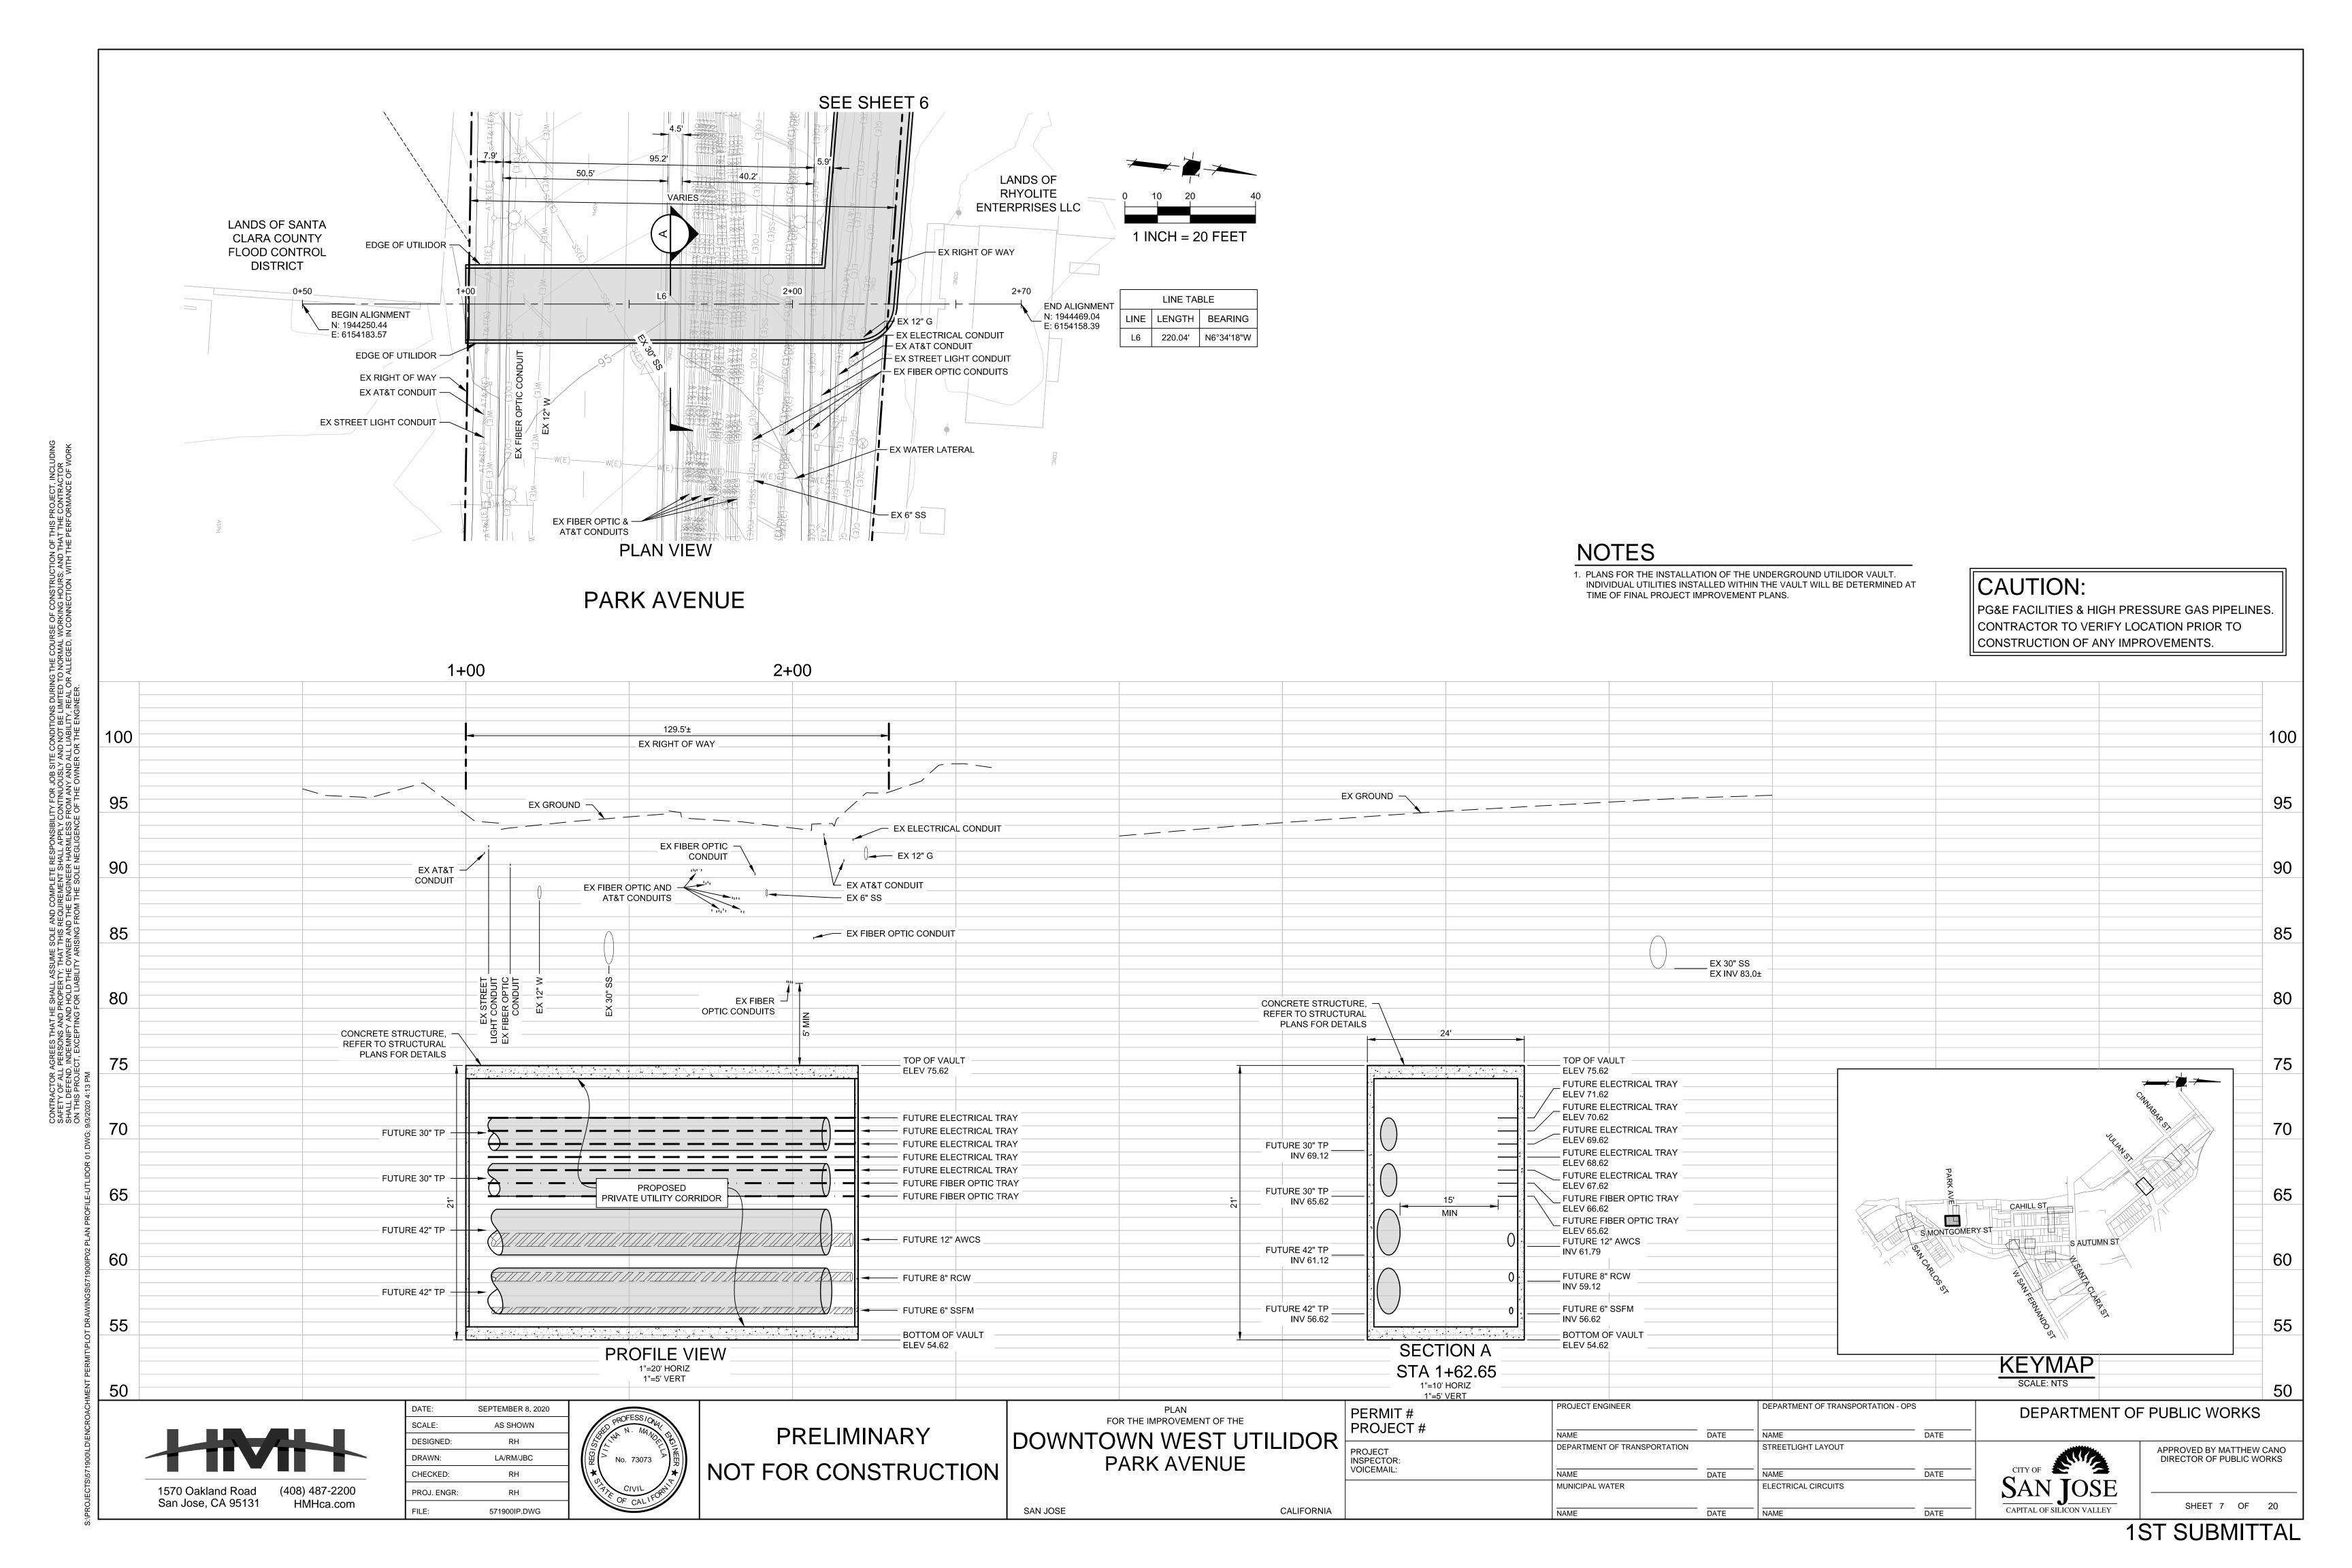

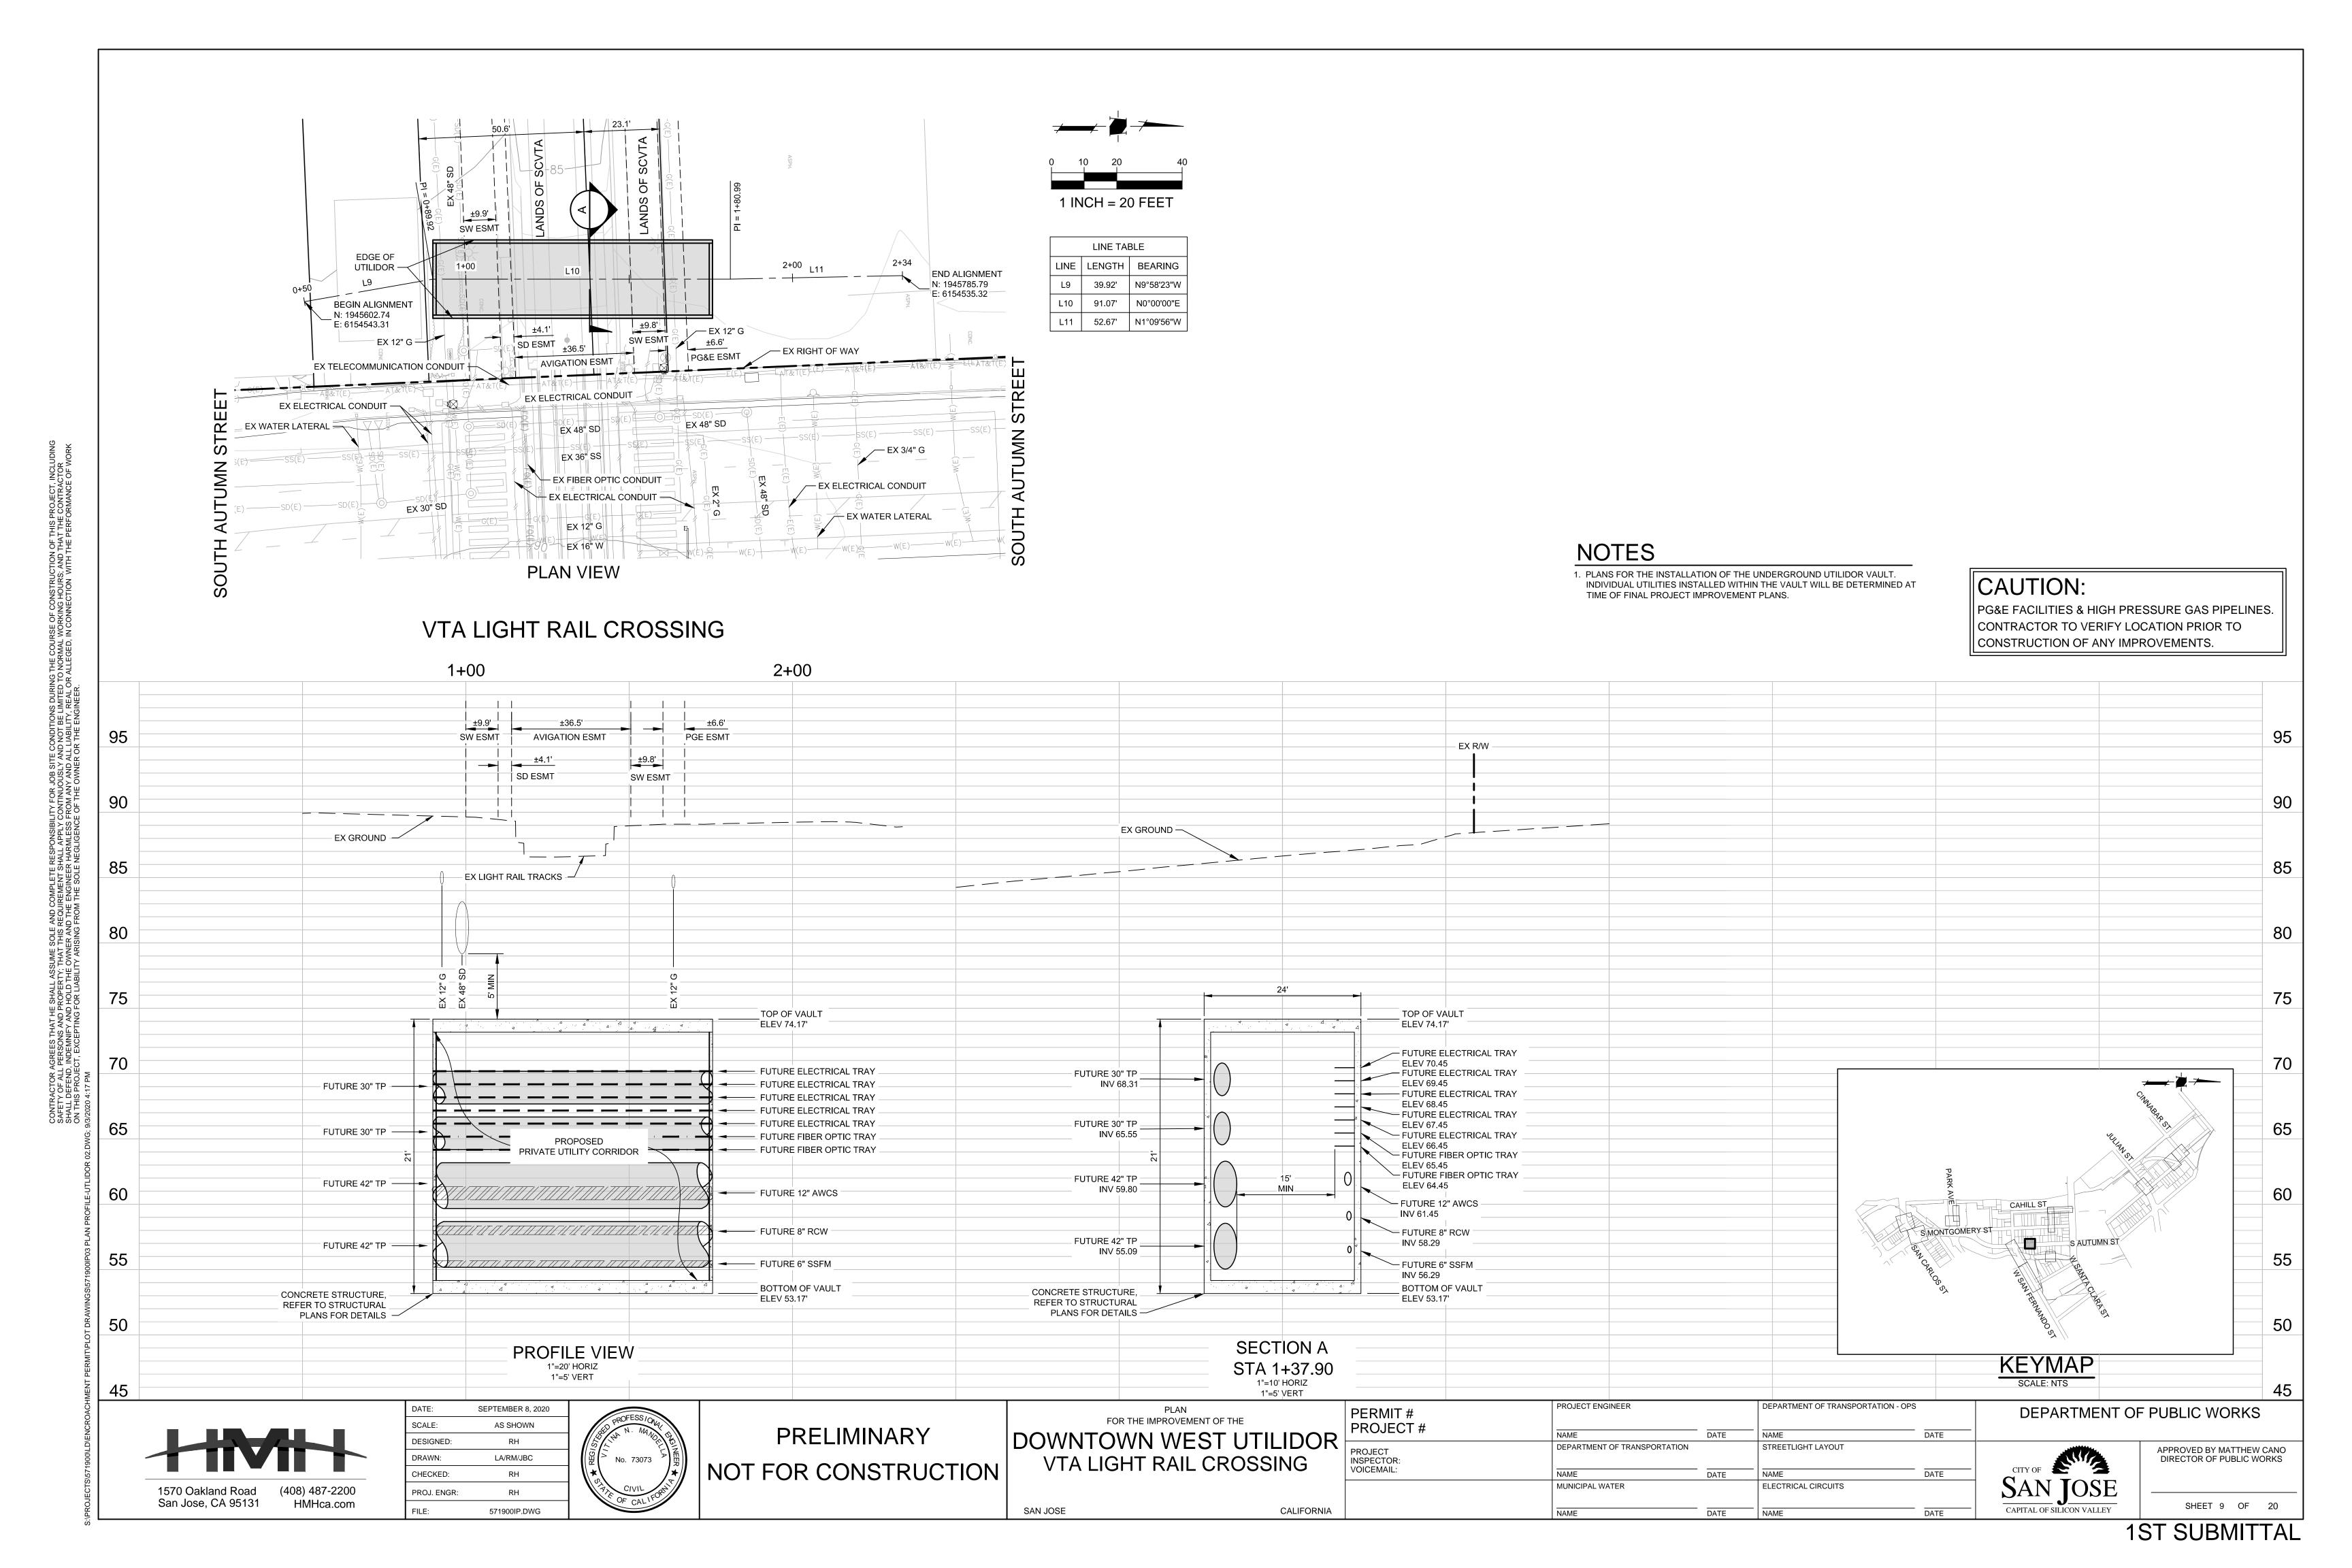

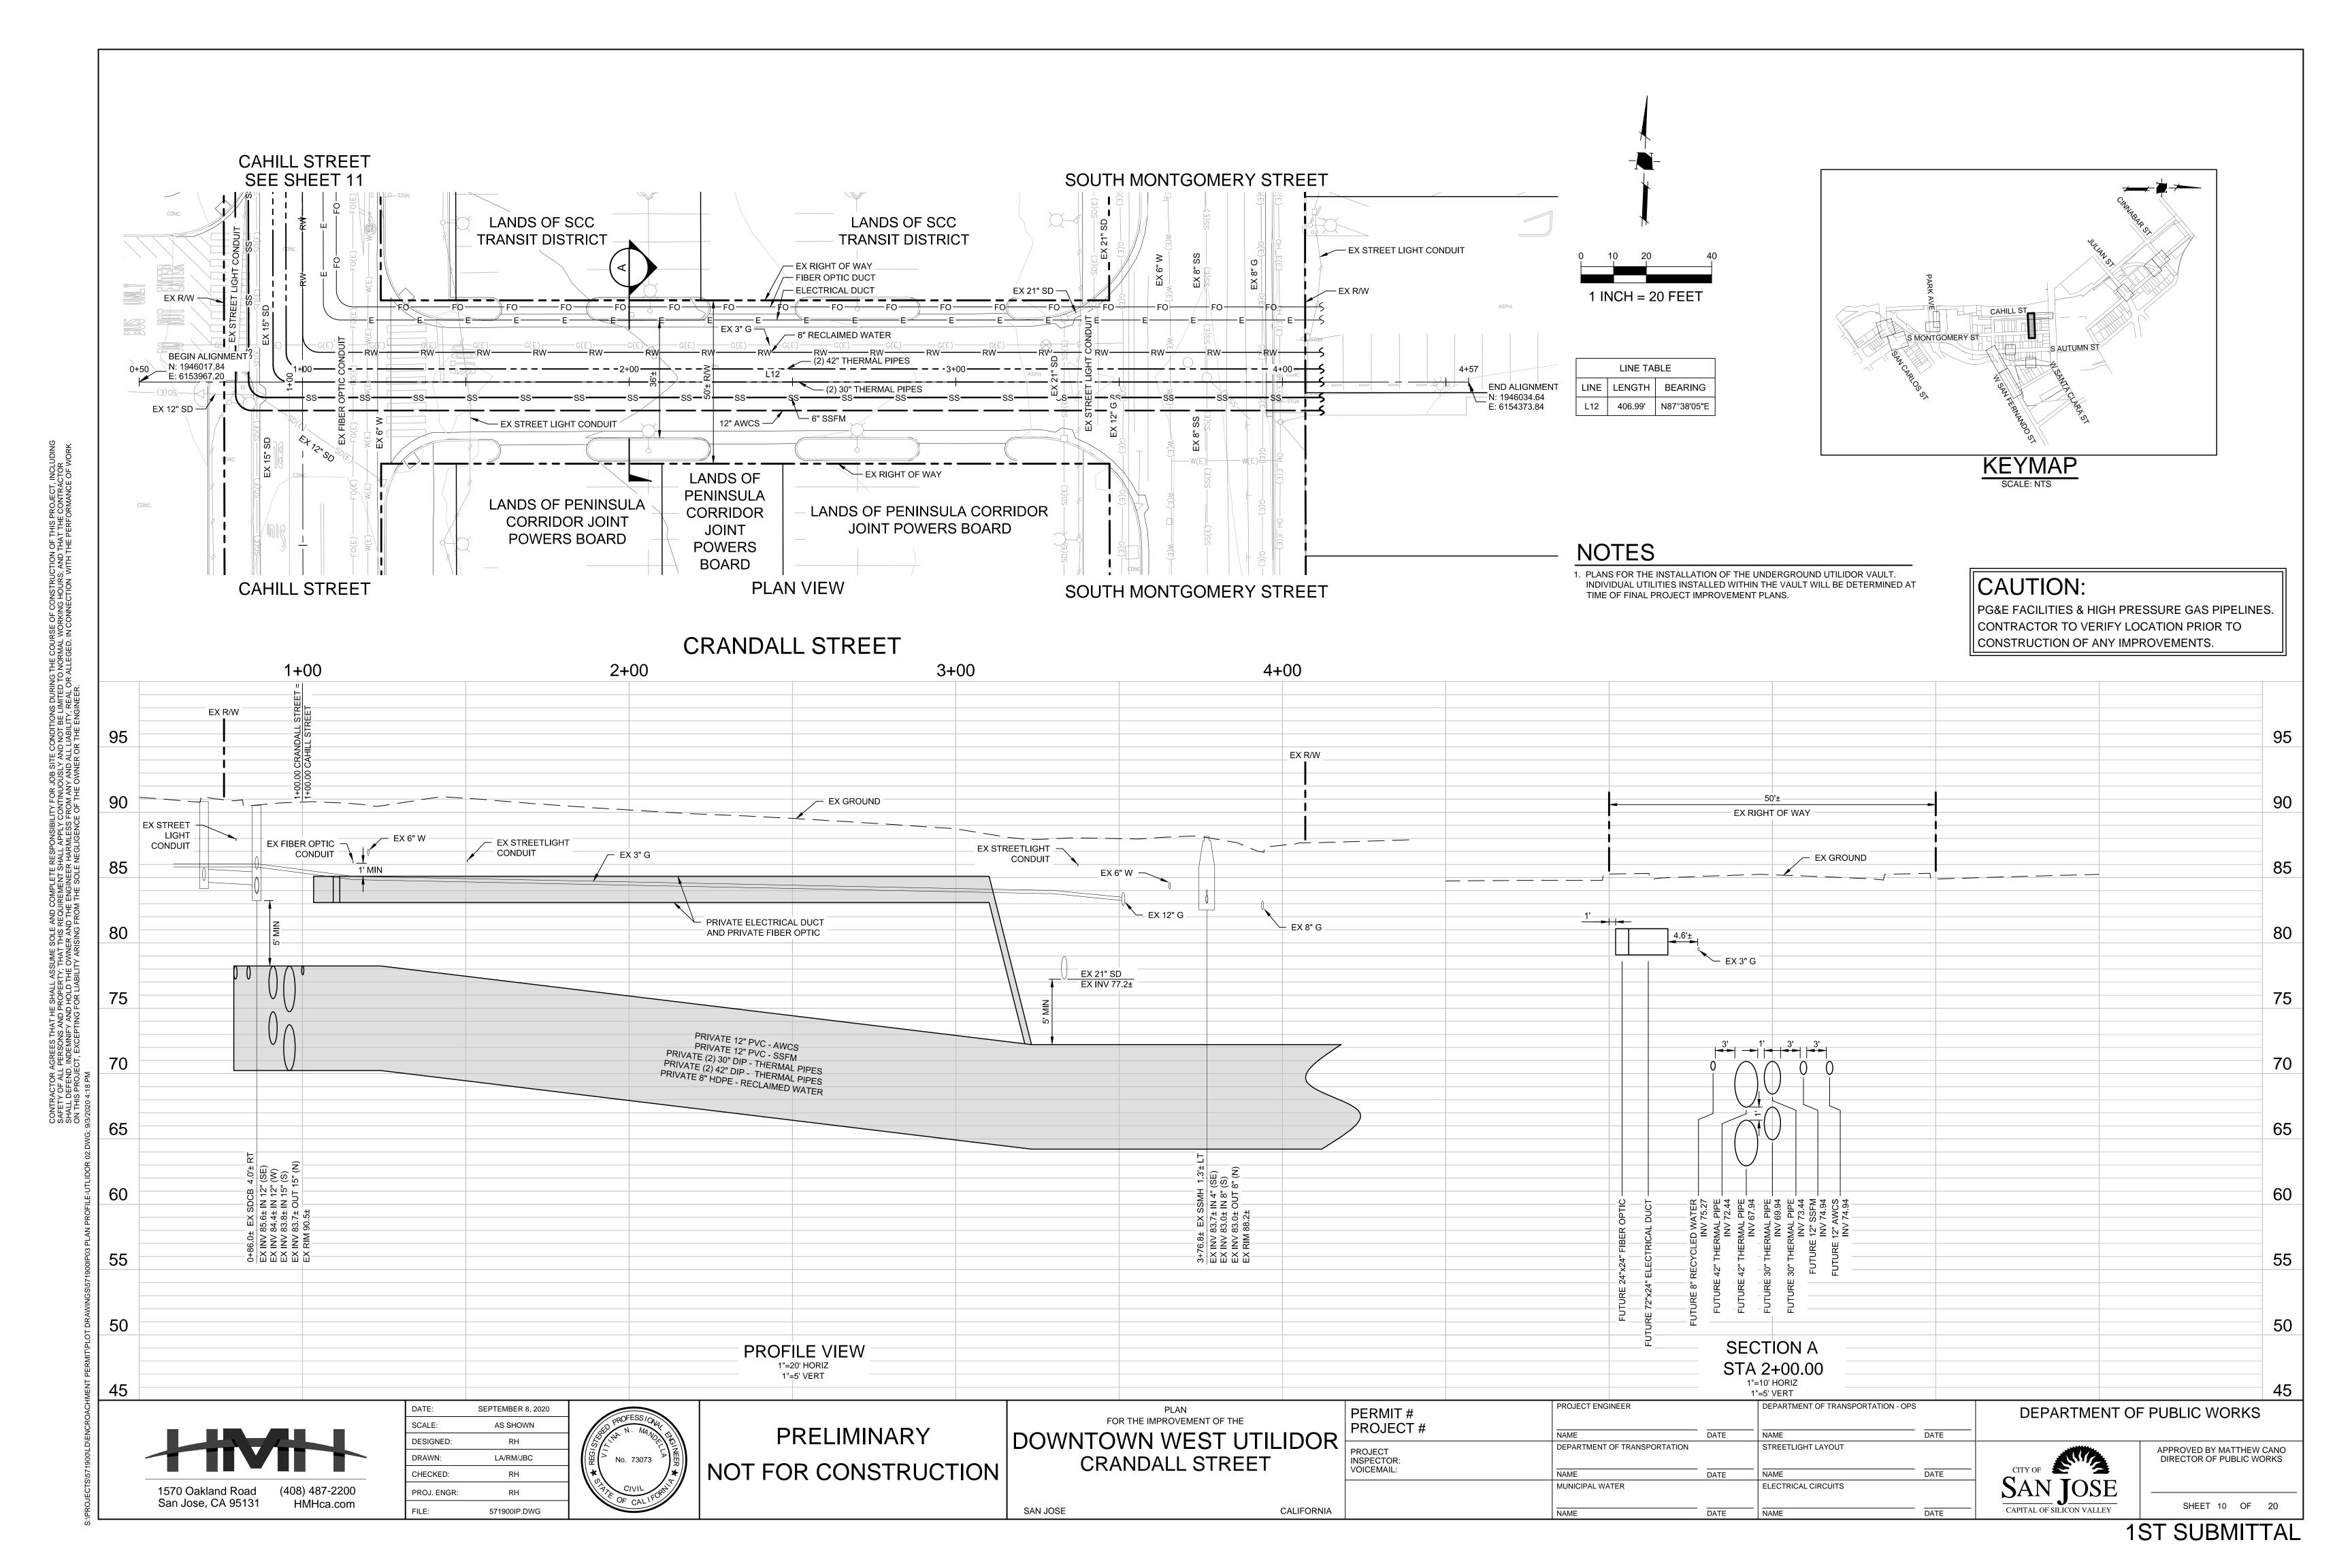

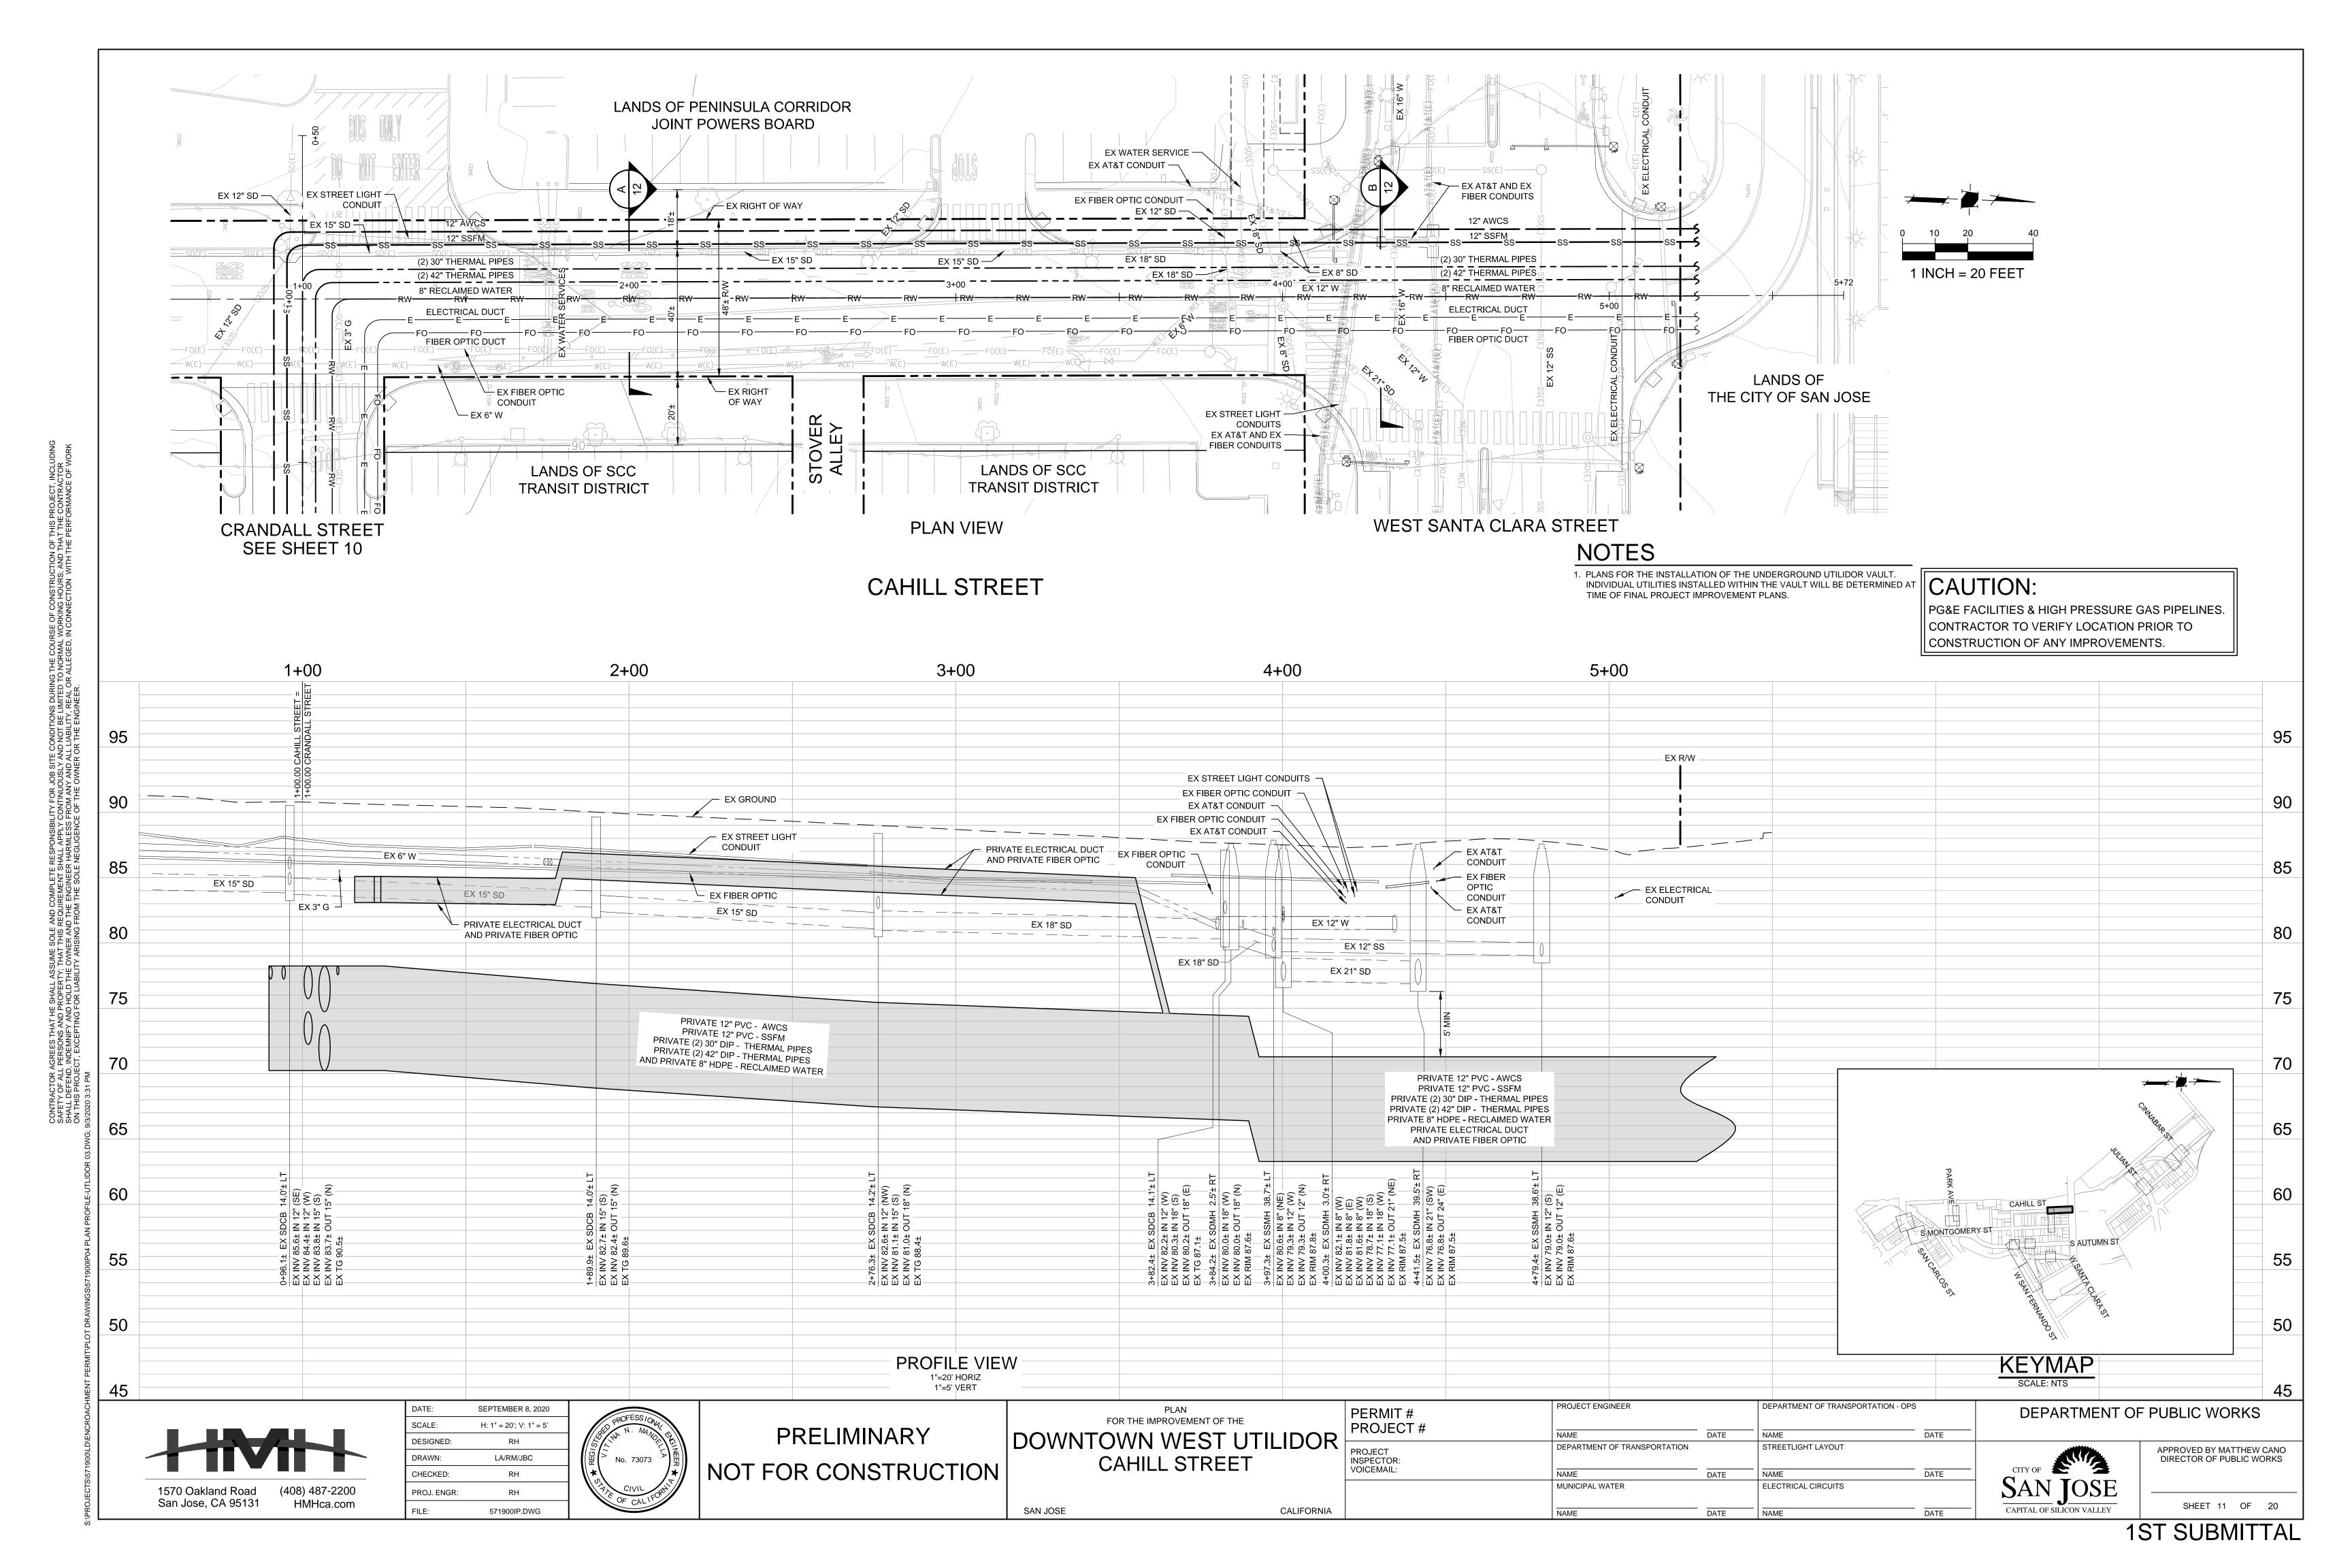


NOTES

1. PLANS FOR THE INSTALLATION OF THE UNDERGROUND UTILIDOR VAULT. INDIVIDUAL UTILITIES INSTALLED WITHIN THE VAULT WILL BE DETERMINED AT TIME OF FINAL PROJECT IMPROVEMENT PLANS.

CAUTION:

PG&E FACILITIES & HIGH PRESSURE GAS PIPELINES. CONTRACTOR TO VERIFY LOCATION PRIOR TO CONSTRUCTION OF ANY IMPROVEMENTS.

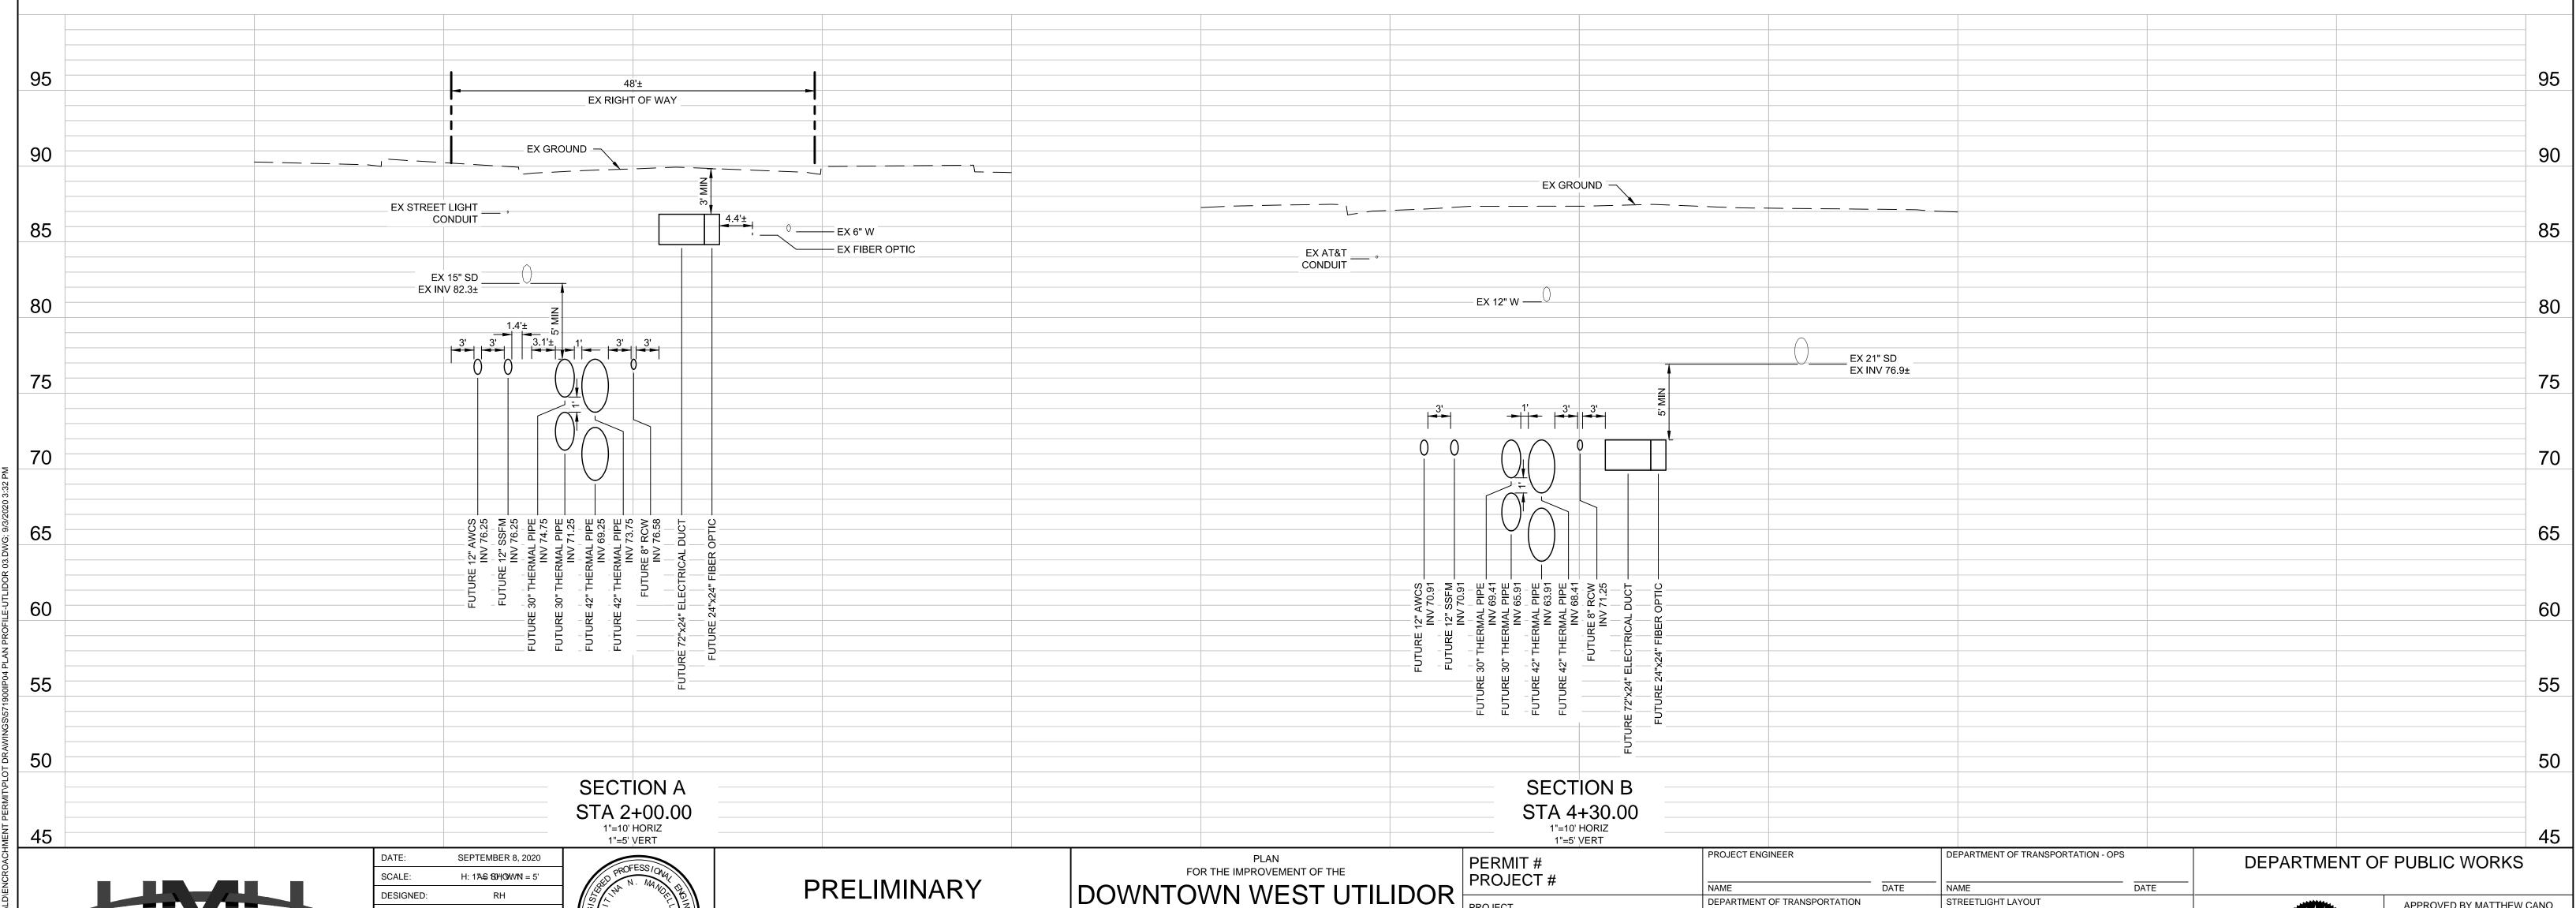

LA/RM/JBC CHECKED: RH RH PROJ. ENGR: 571900IP.DWG



NOT FOR CONSTRUCTION

DOWNTOWN WEST UTILIDOR
CAHILL STREET SECTIONS

CALIFORNIA


SAN JOSE


DEPARTMENT OF TRANSPORTATION ELECTRICAL CIRCUITS MUNICIPAL WATER


DATE NAME


APPROVED BY MATTHEW CANO DIRECTOR OF PUBLIC WORKS

1ST SUBMITTAL

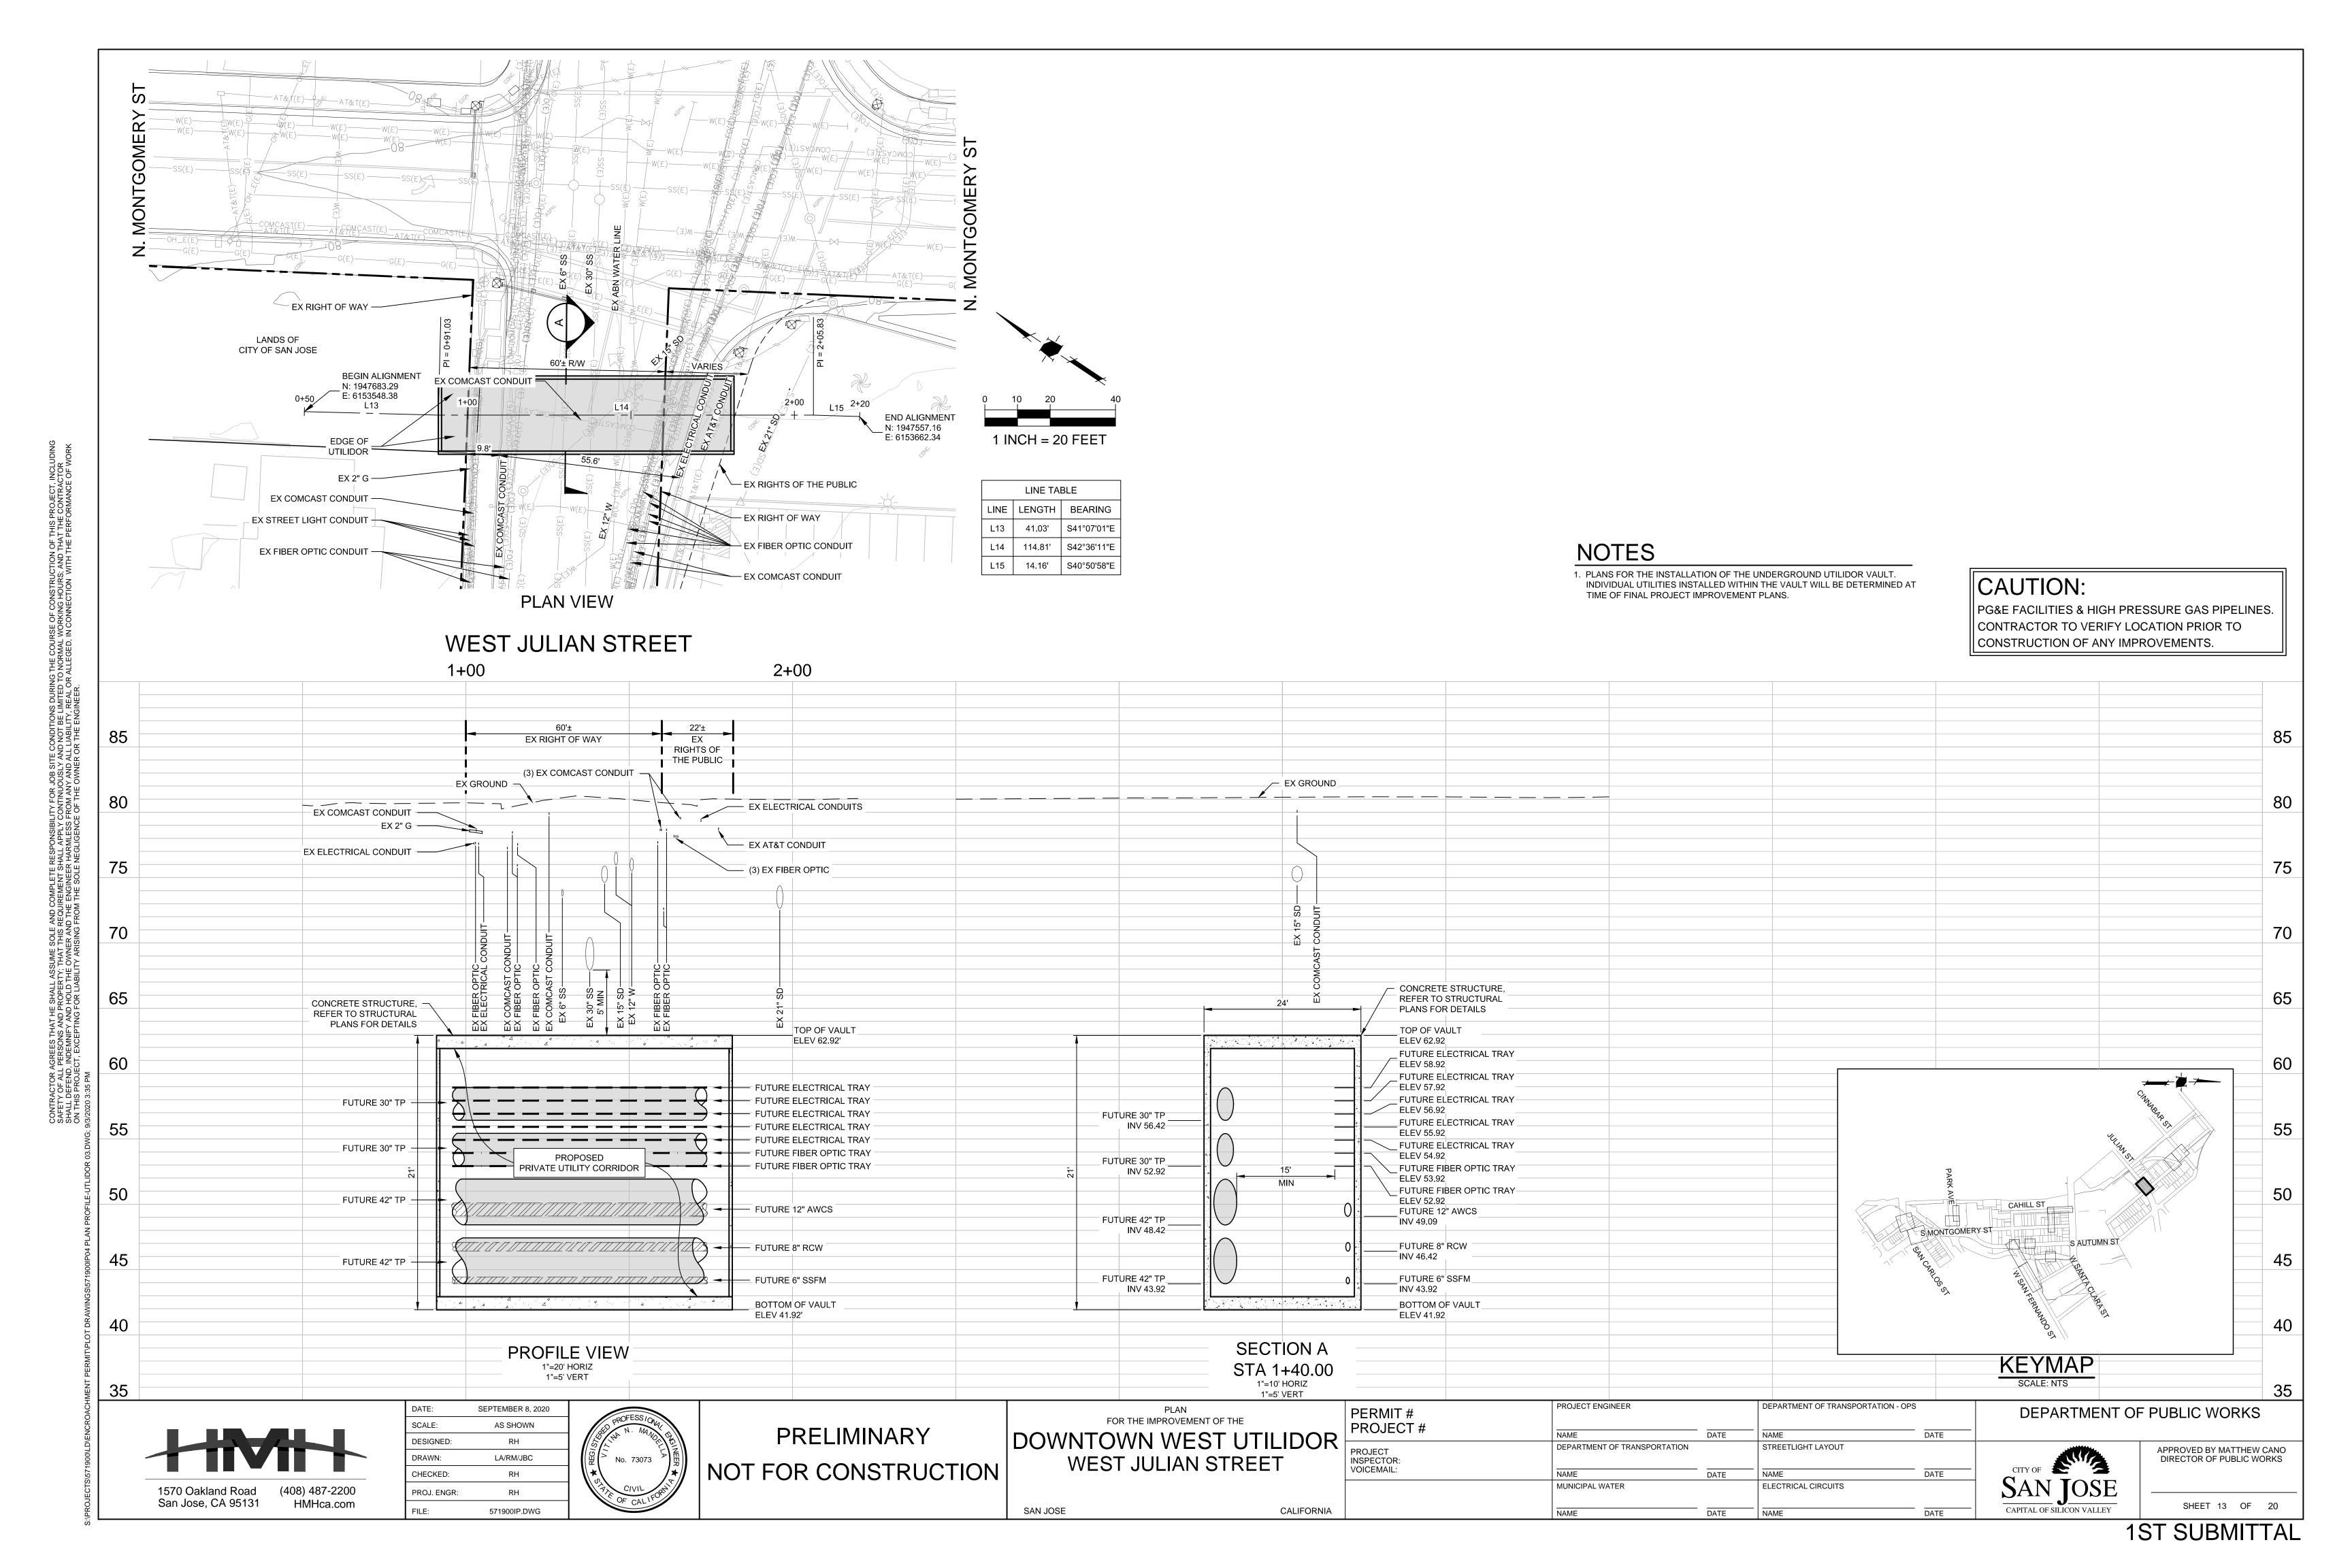

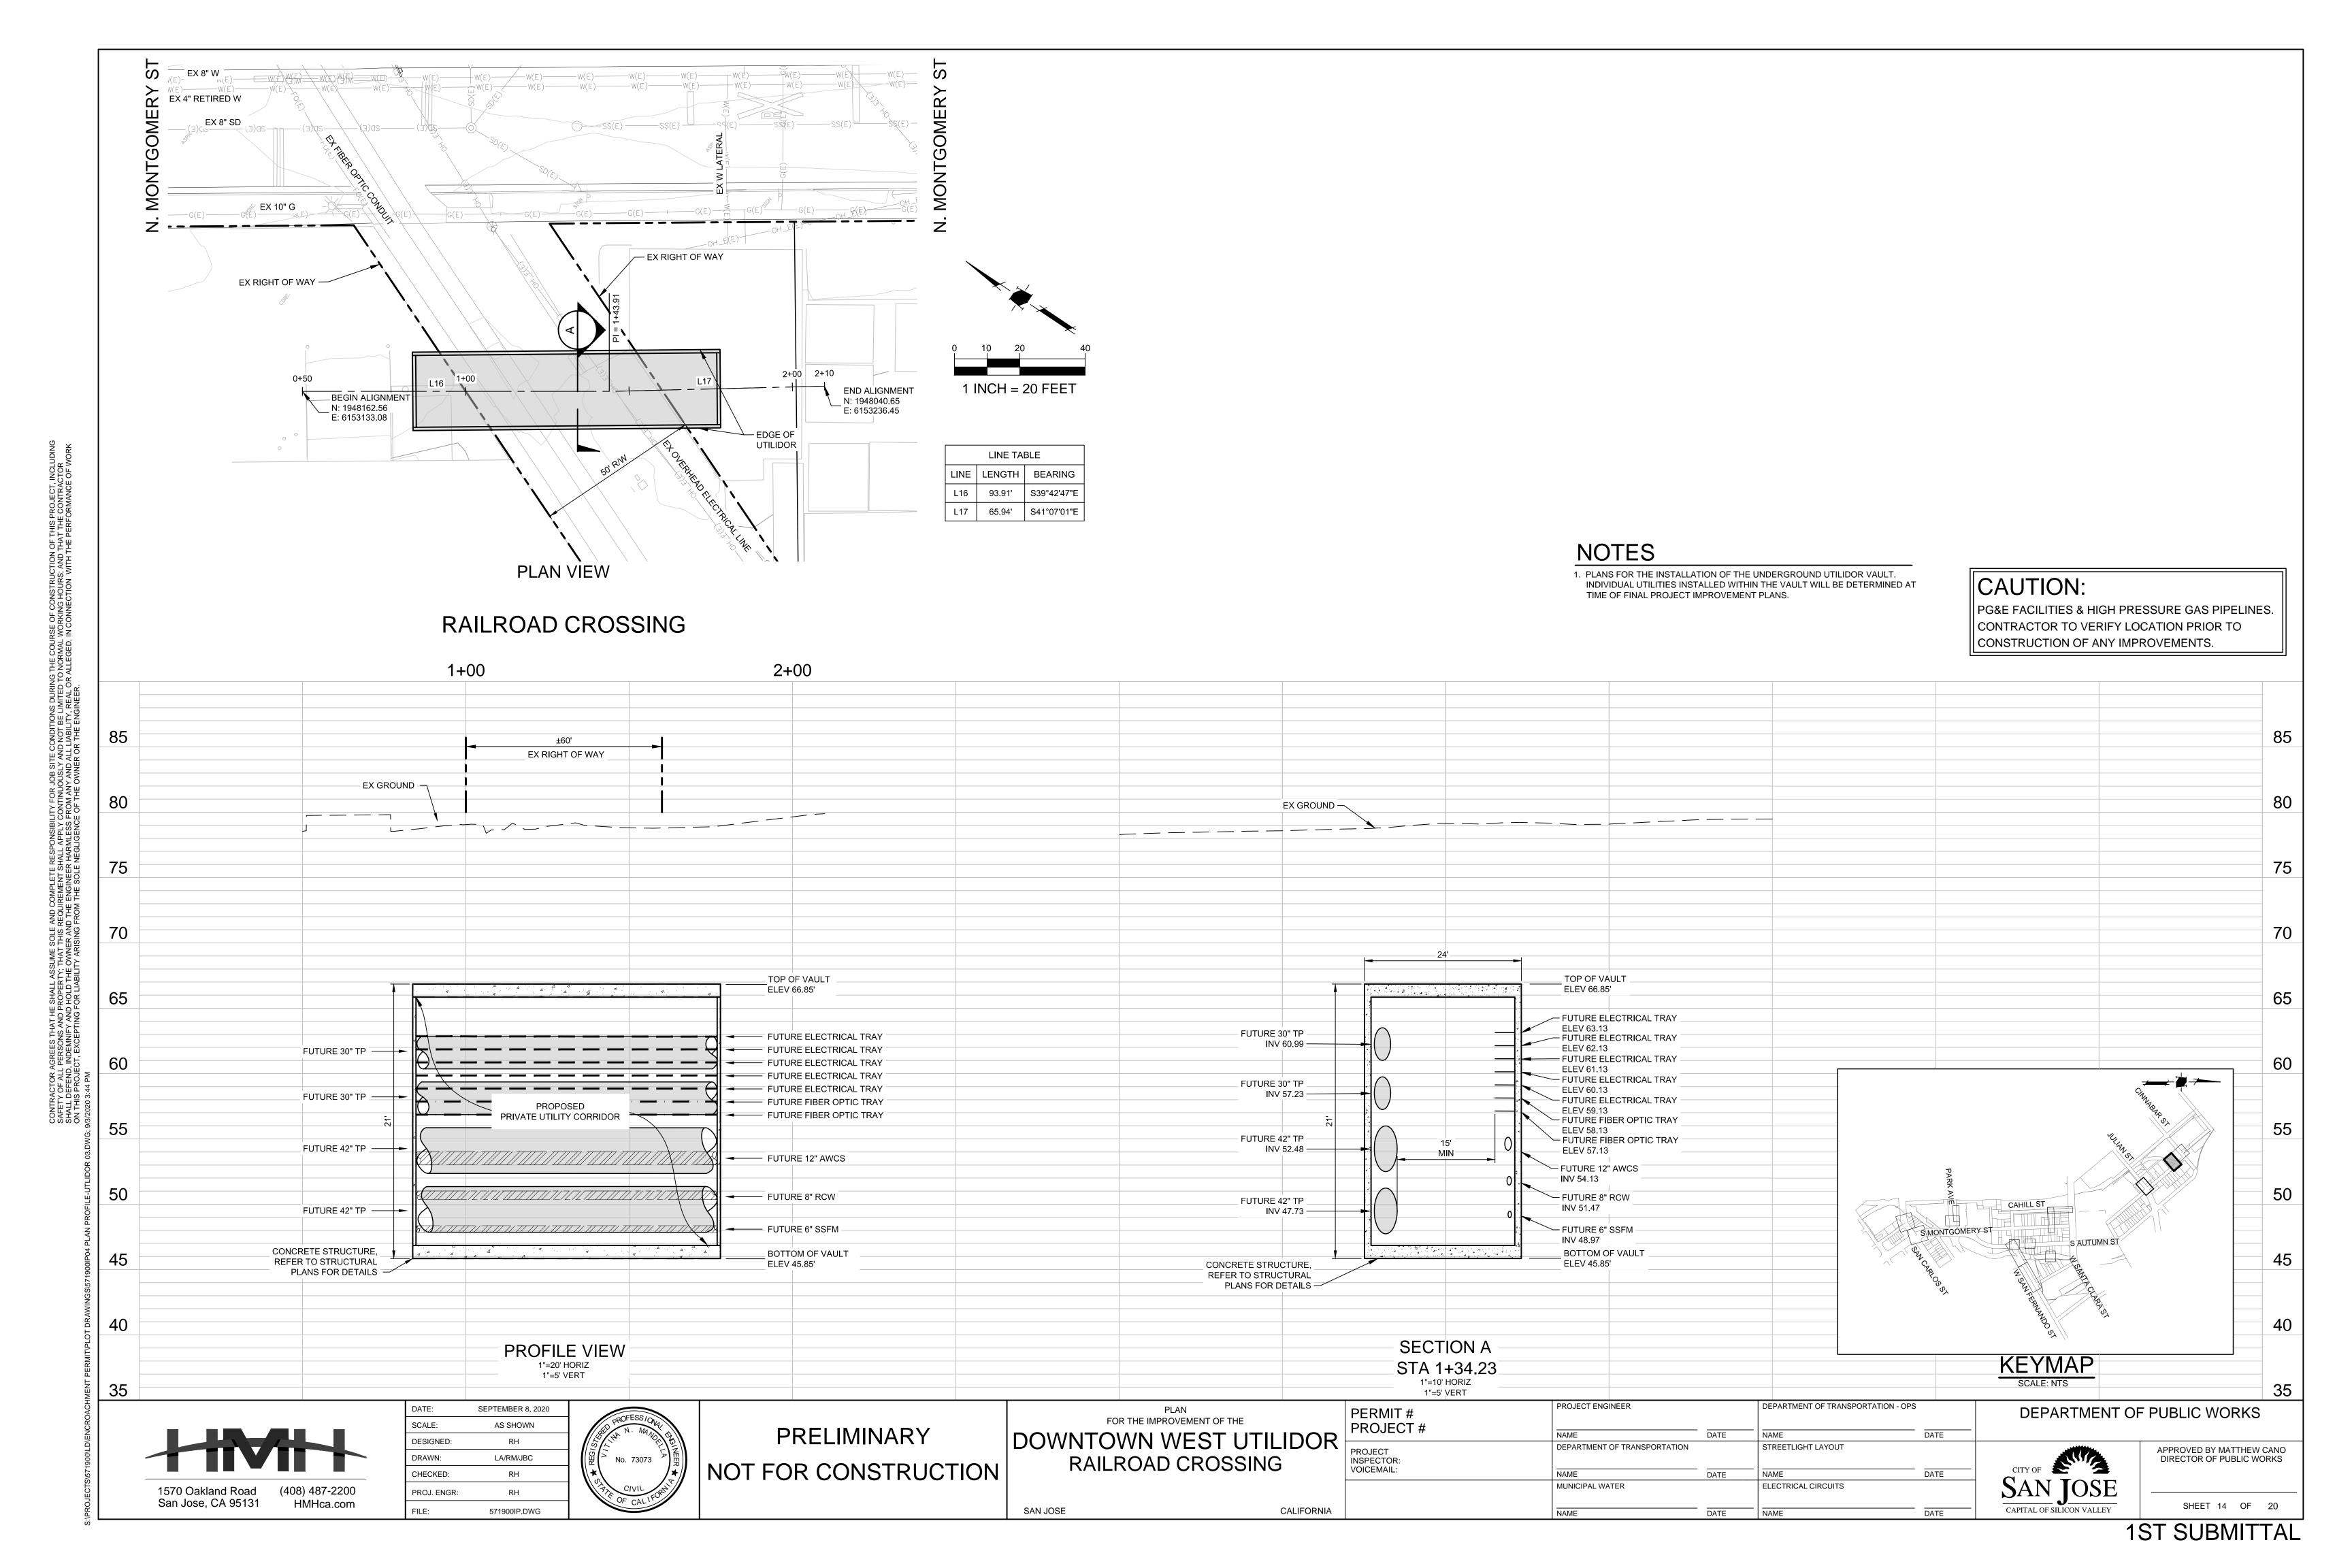

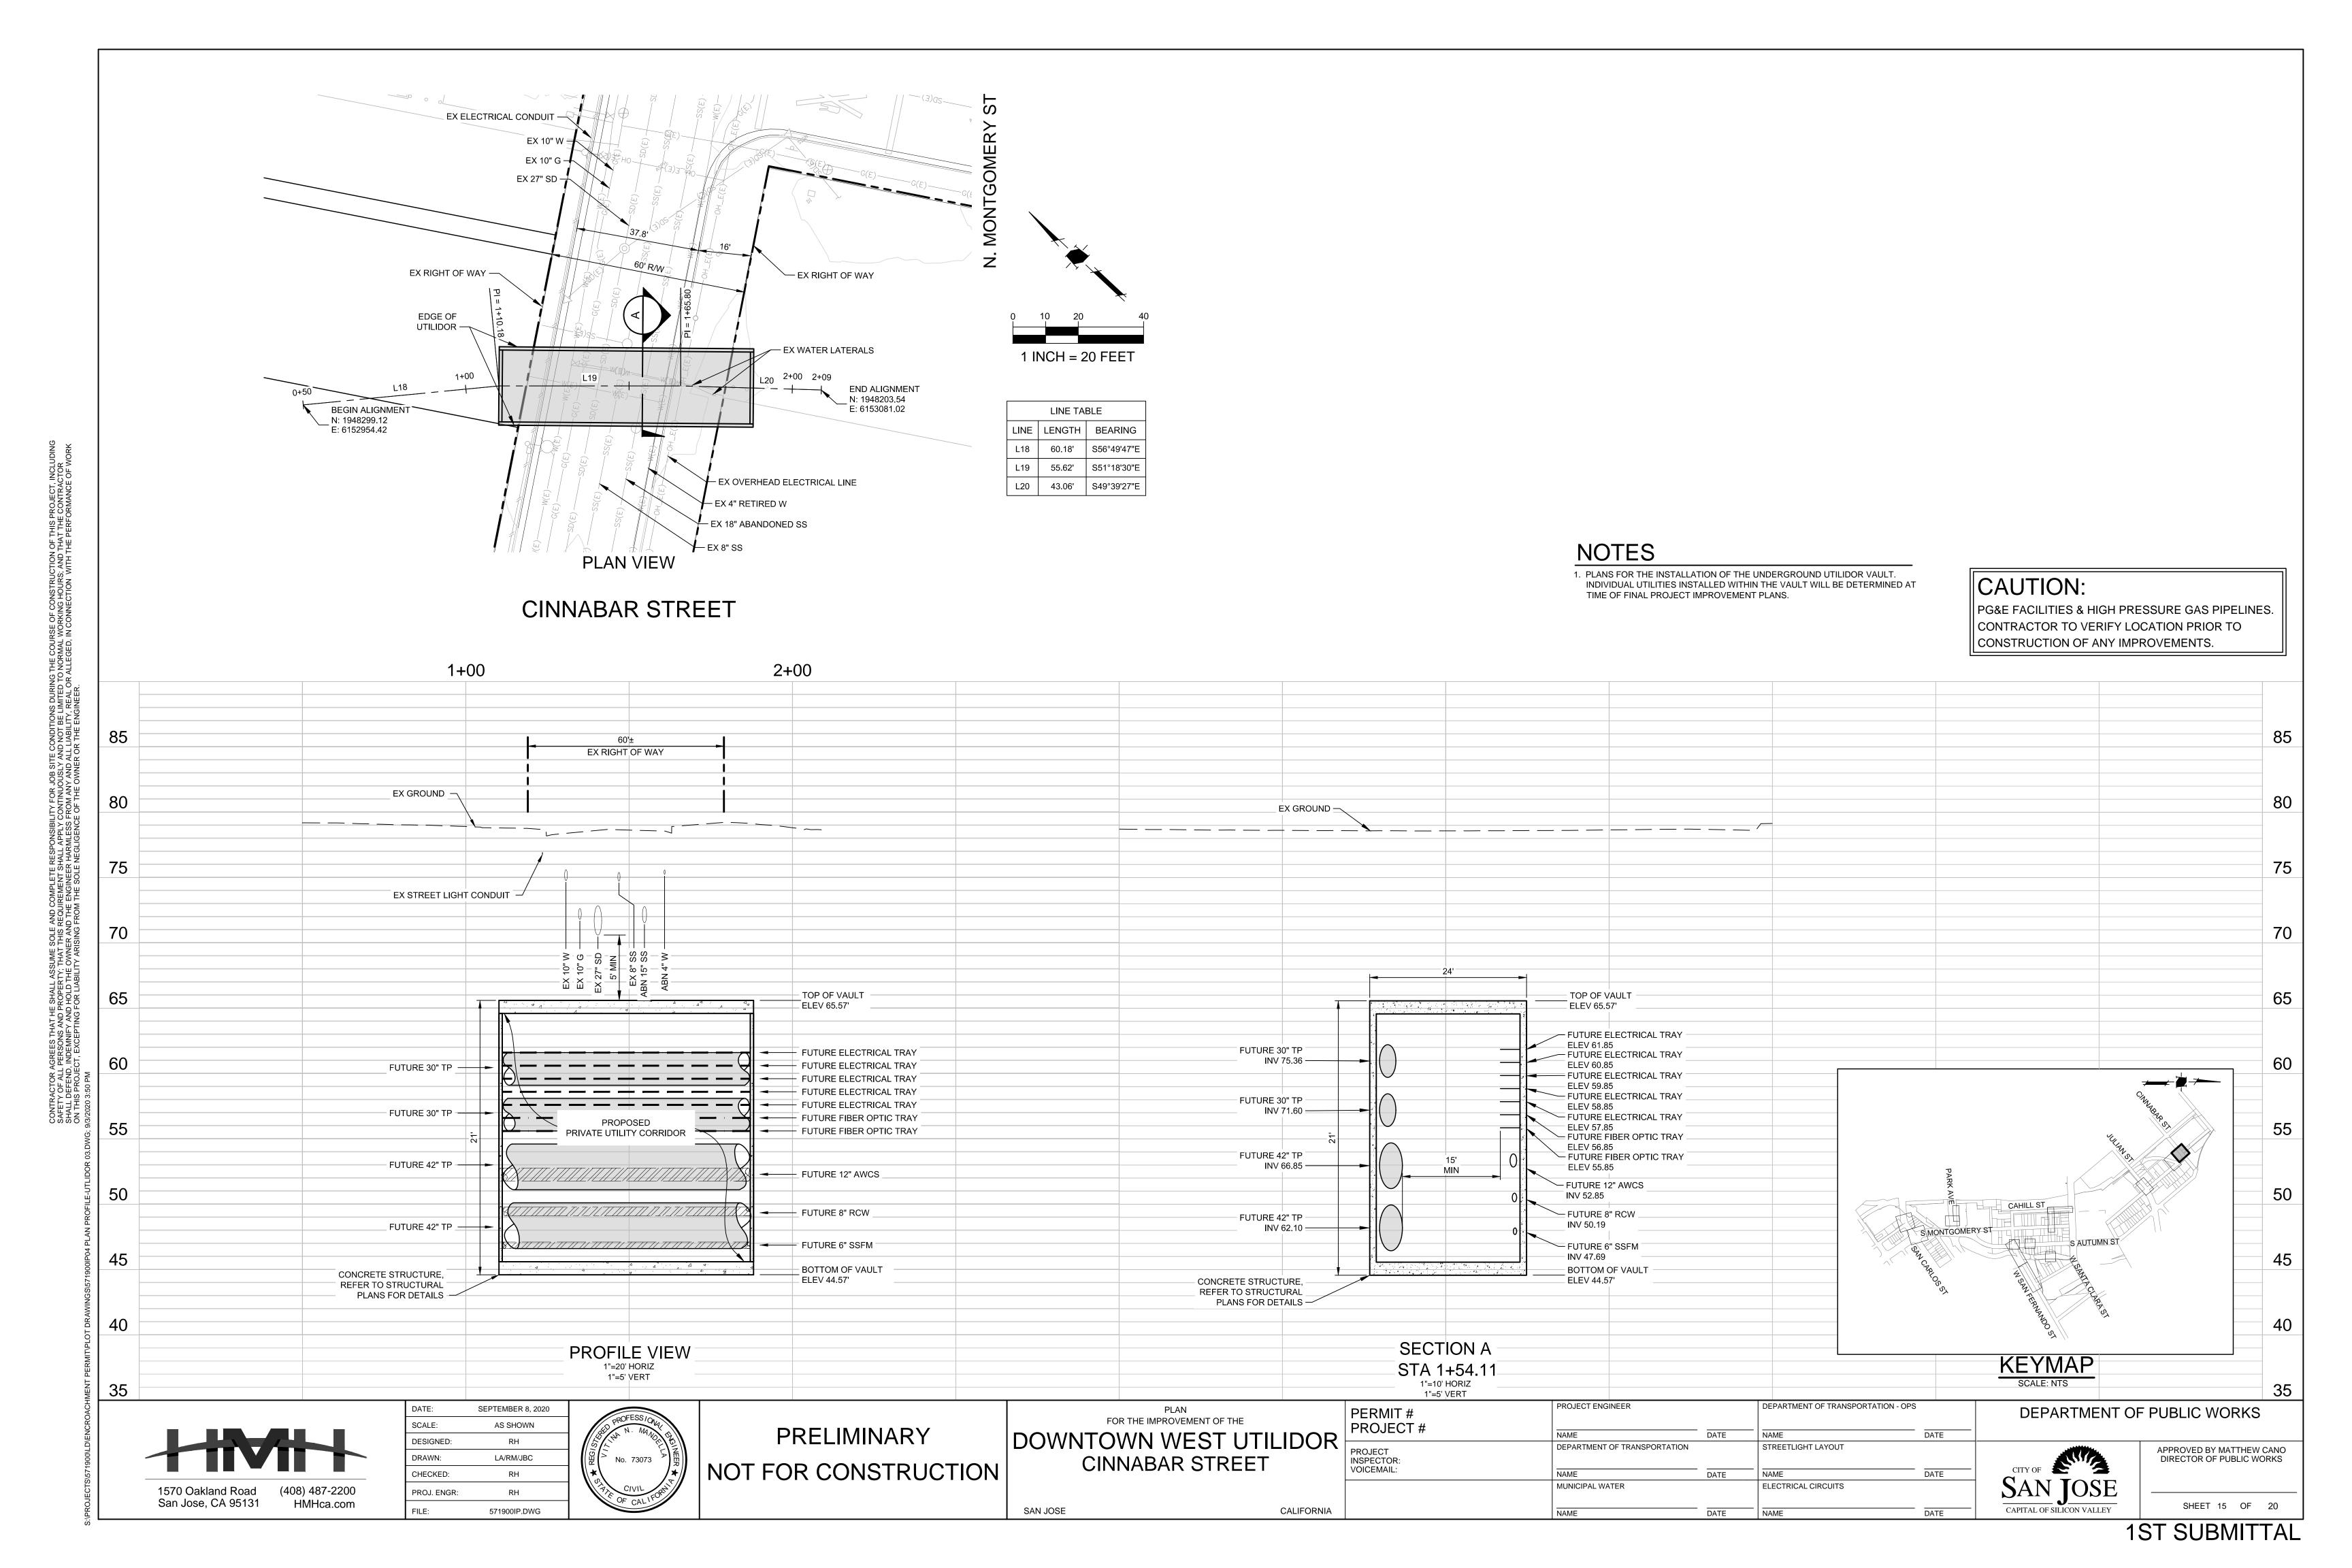

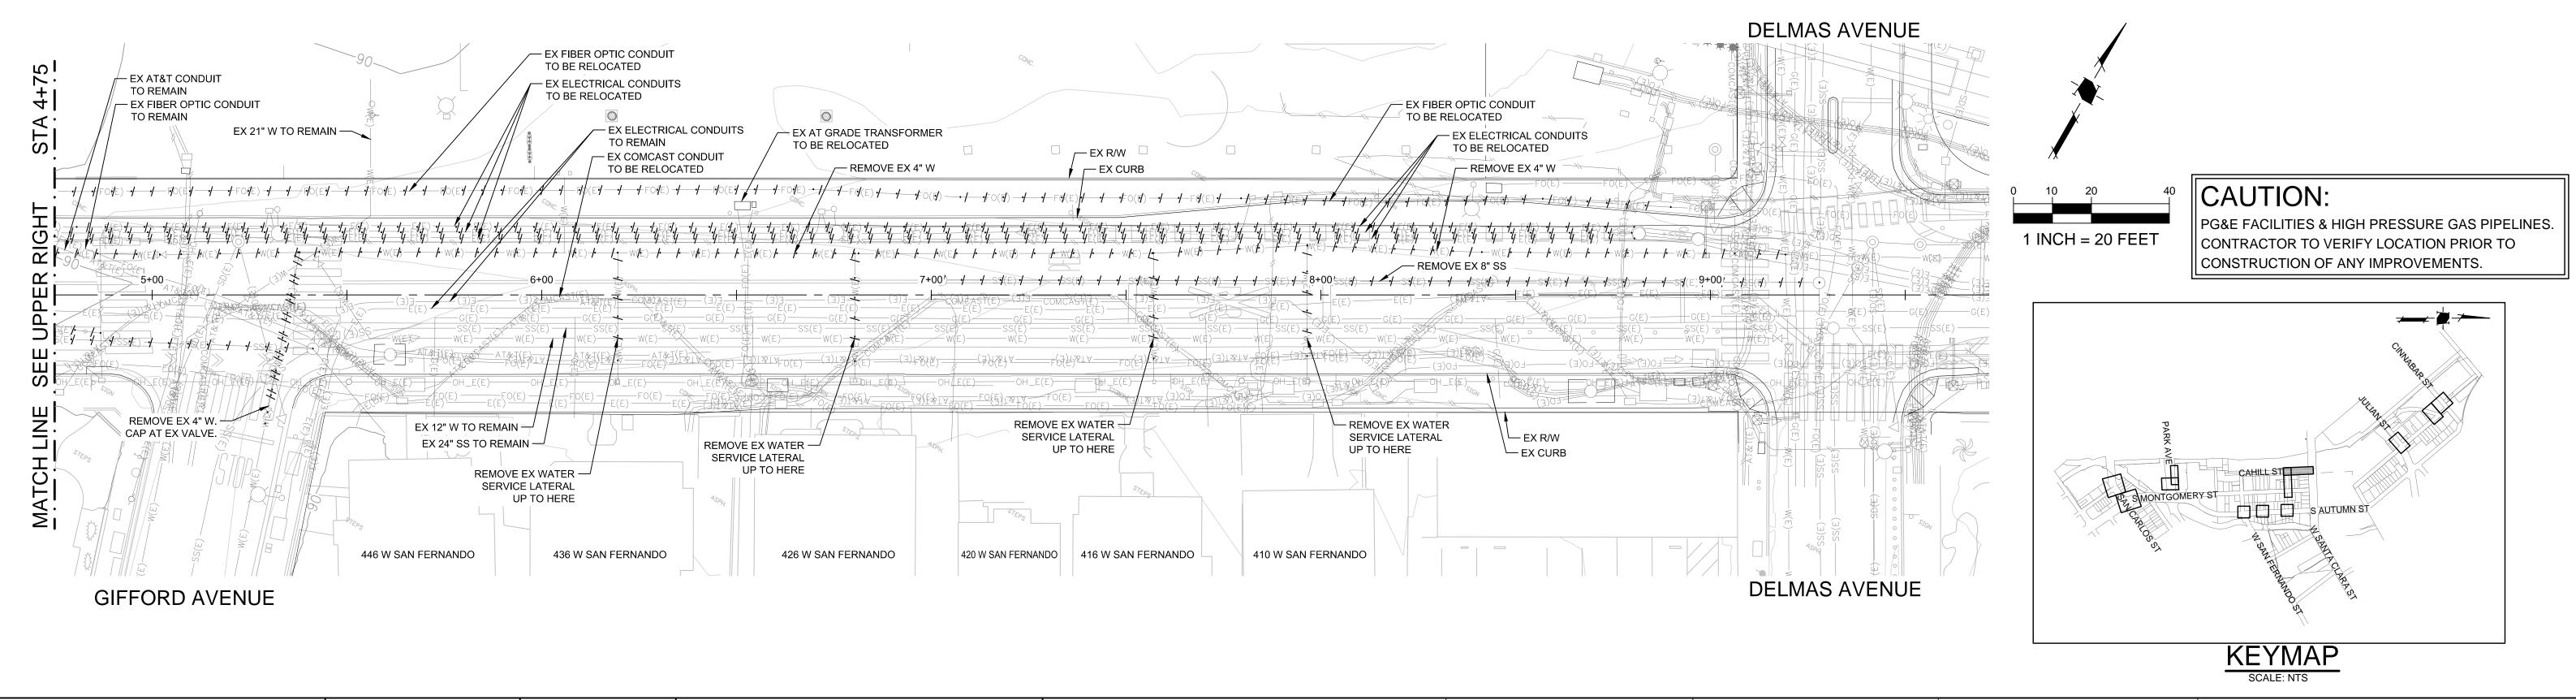



SCALE:

DESIGNED:

CHECKED:

PROJ. ENGR:

DRAWN:


SEPTEMBER 8, 2020	25500
1" = 20'	PROFESS/ONALL
RH	N. MANOR BE
LA/RM/JBC	SB(> No. 73073
RH	*\
RH	OF CALIFORNIA
571900IP.DWG	OF CALL


PRELIMINARY NOT FOR CONSTRUCTION


FOR THE IMPROVEMENT OF THE DOWNTOWN WEST UTILIDOR	
DEMOLITION PLAN	PF IN: VC
WEST SAN FERNANDO STREET	
SAN JOSE CALIFORNIA	

ERMIT # ROJECT #	PROJECT ENGINEER NAME	DATE	DEPARTMENT OF TRANSPORTATION - O	DATE	DEPARTMENT OF	F PUBLIC WORKS
OJECT SPECTOR:	DEPARTMENT OF TRANSPORTATION		STREETLIGHT LAYOUT			APPROVED BY MATTHEW CA DIRECTOR OF PUBLIC WOR
DICEMAIL:	NAME	DATE	NAME	DATE	CITY OF	
	MUNICIPAL WATER		ELECTRICAL CIRCUITS		SAN JOSE	

APPROVED BY MATTHEW CANO DIRECTOR OF PUBLIC WORKS

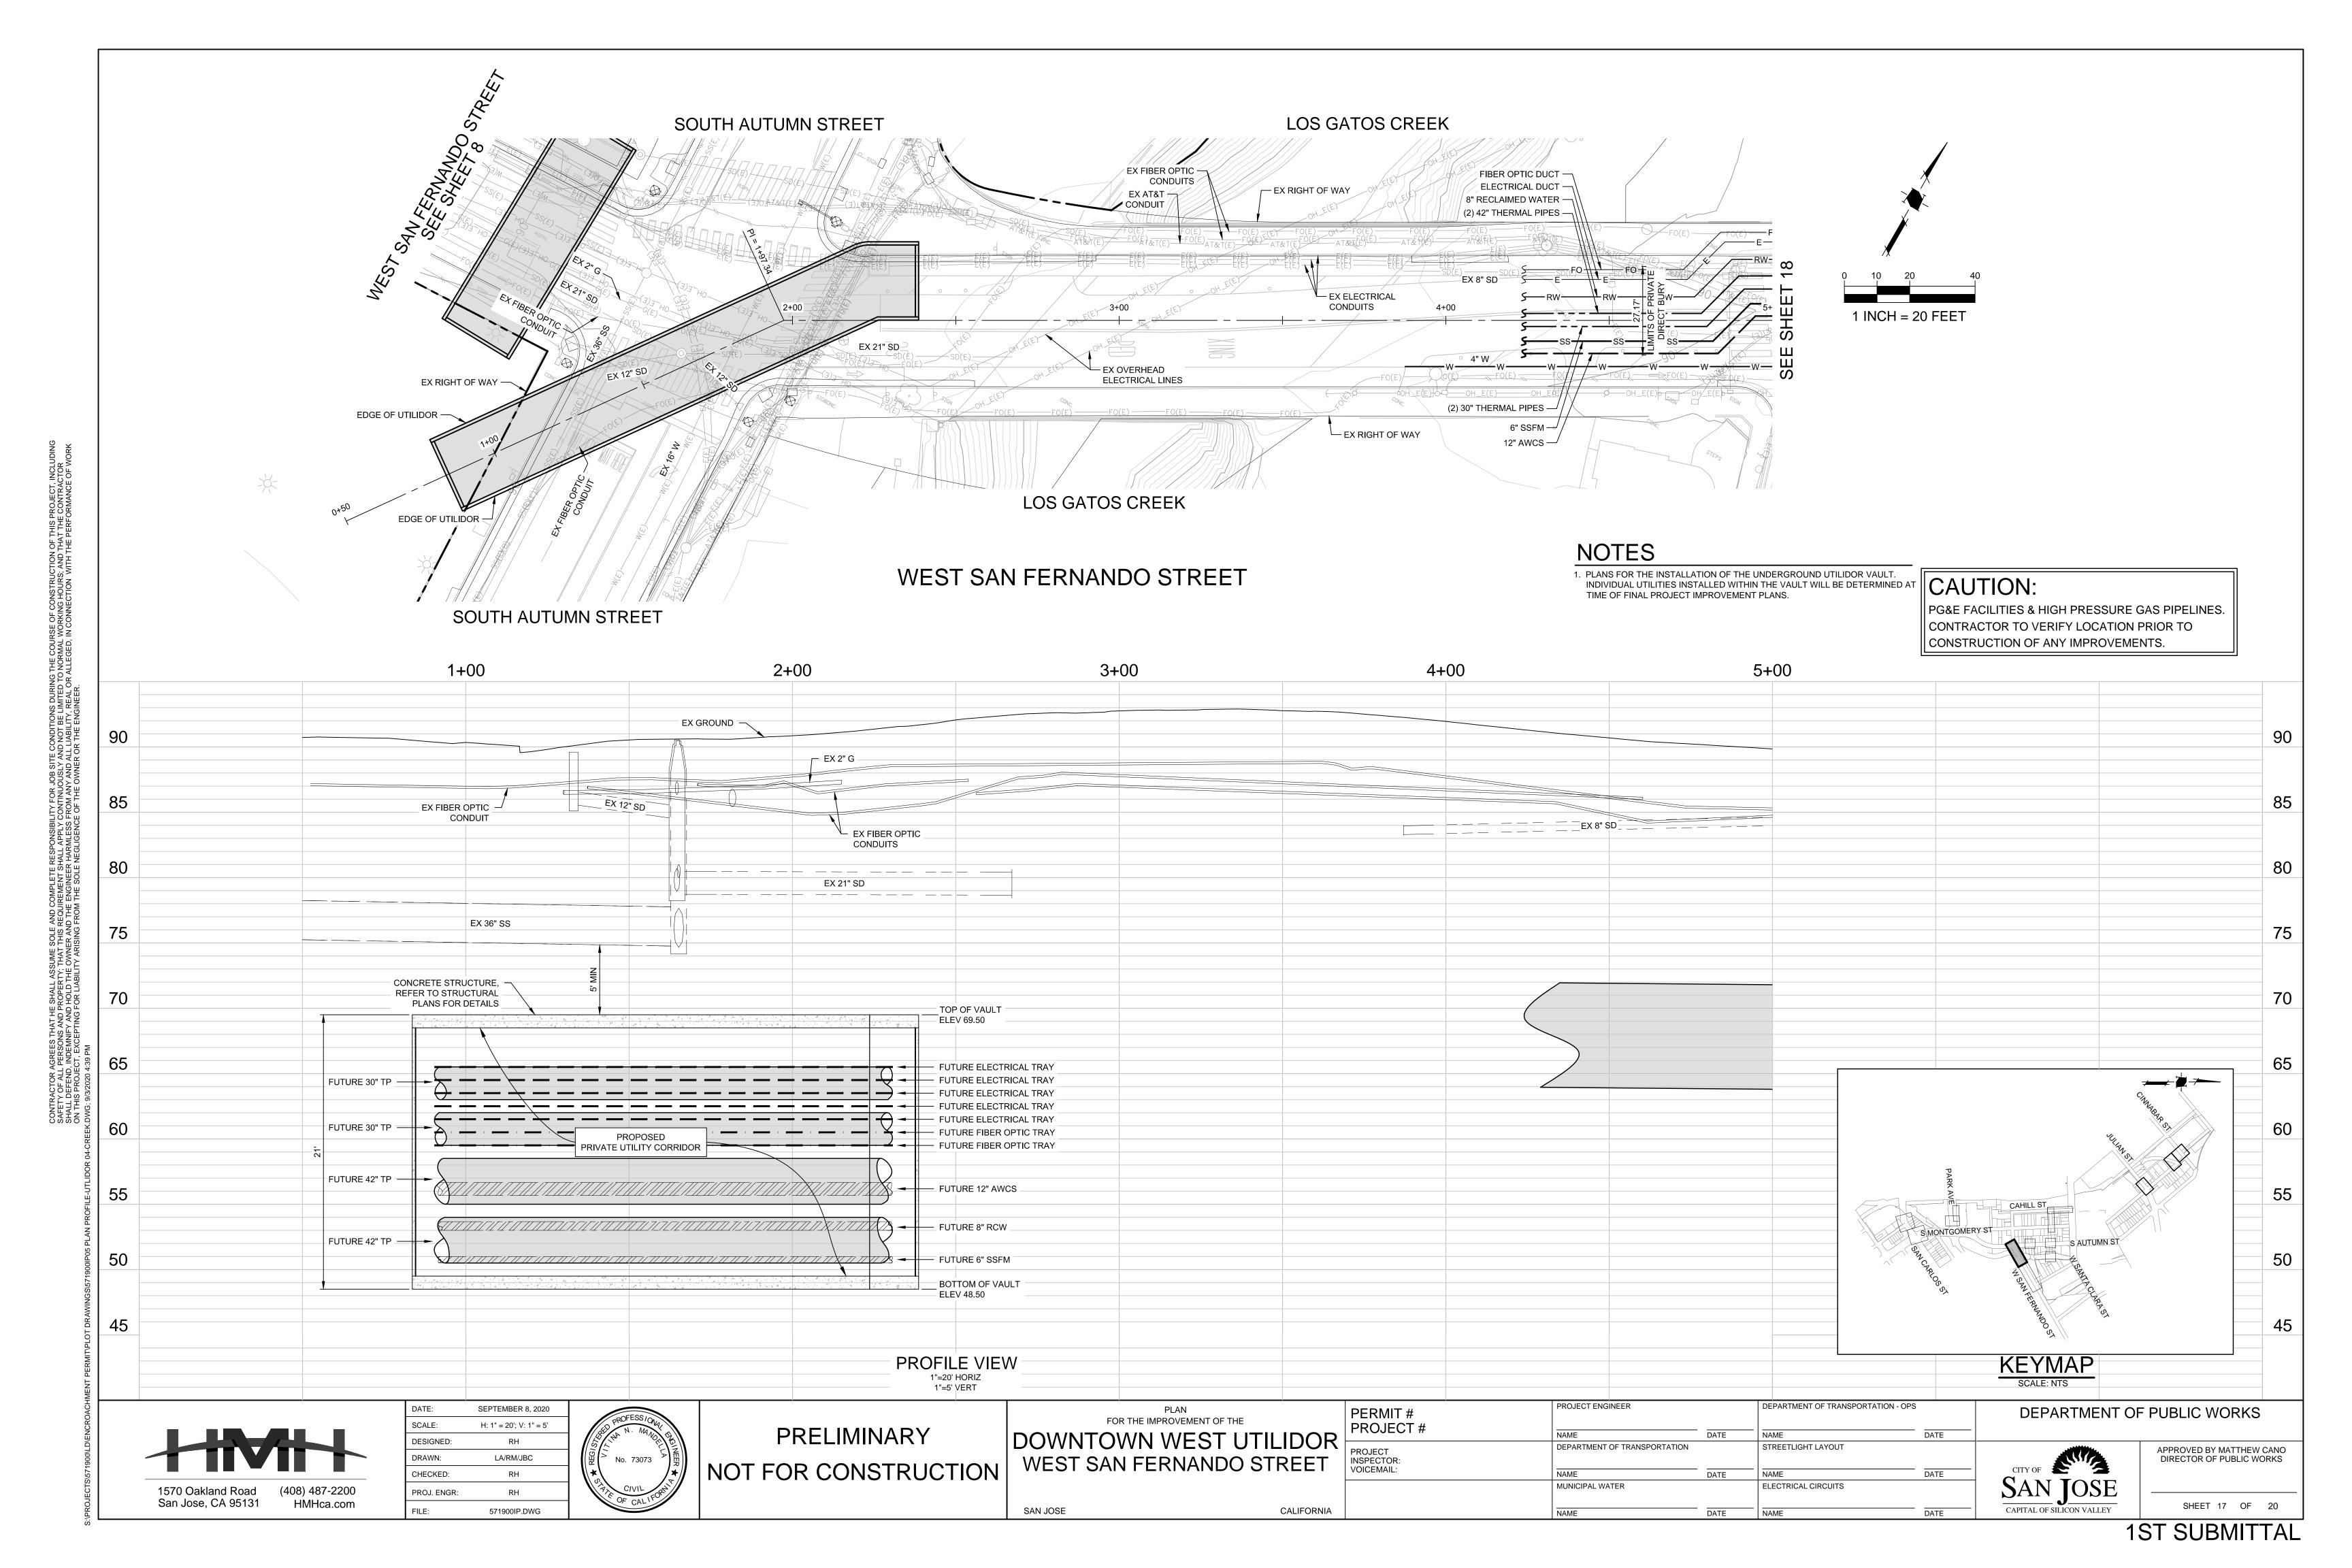

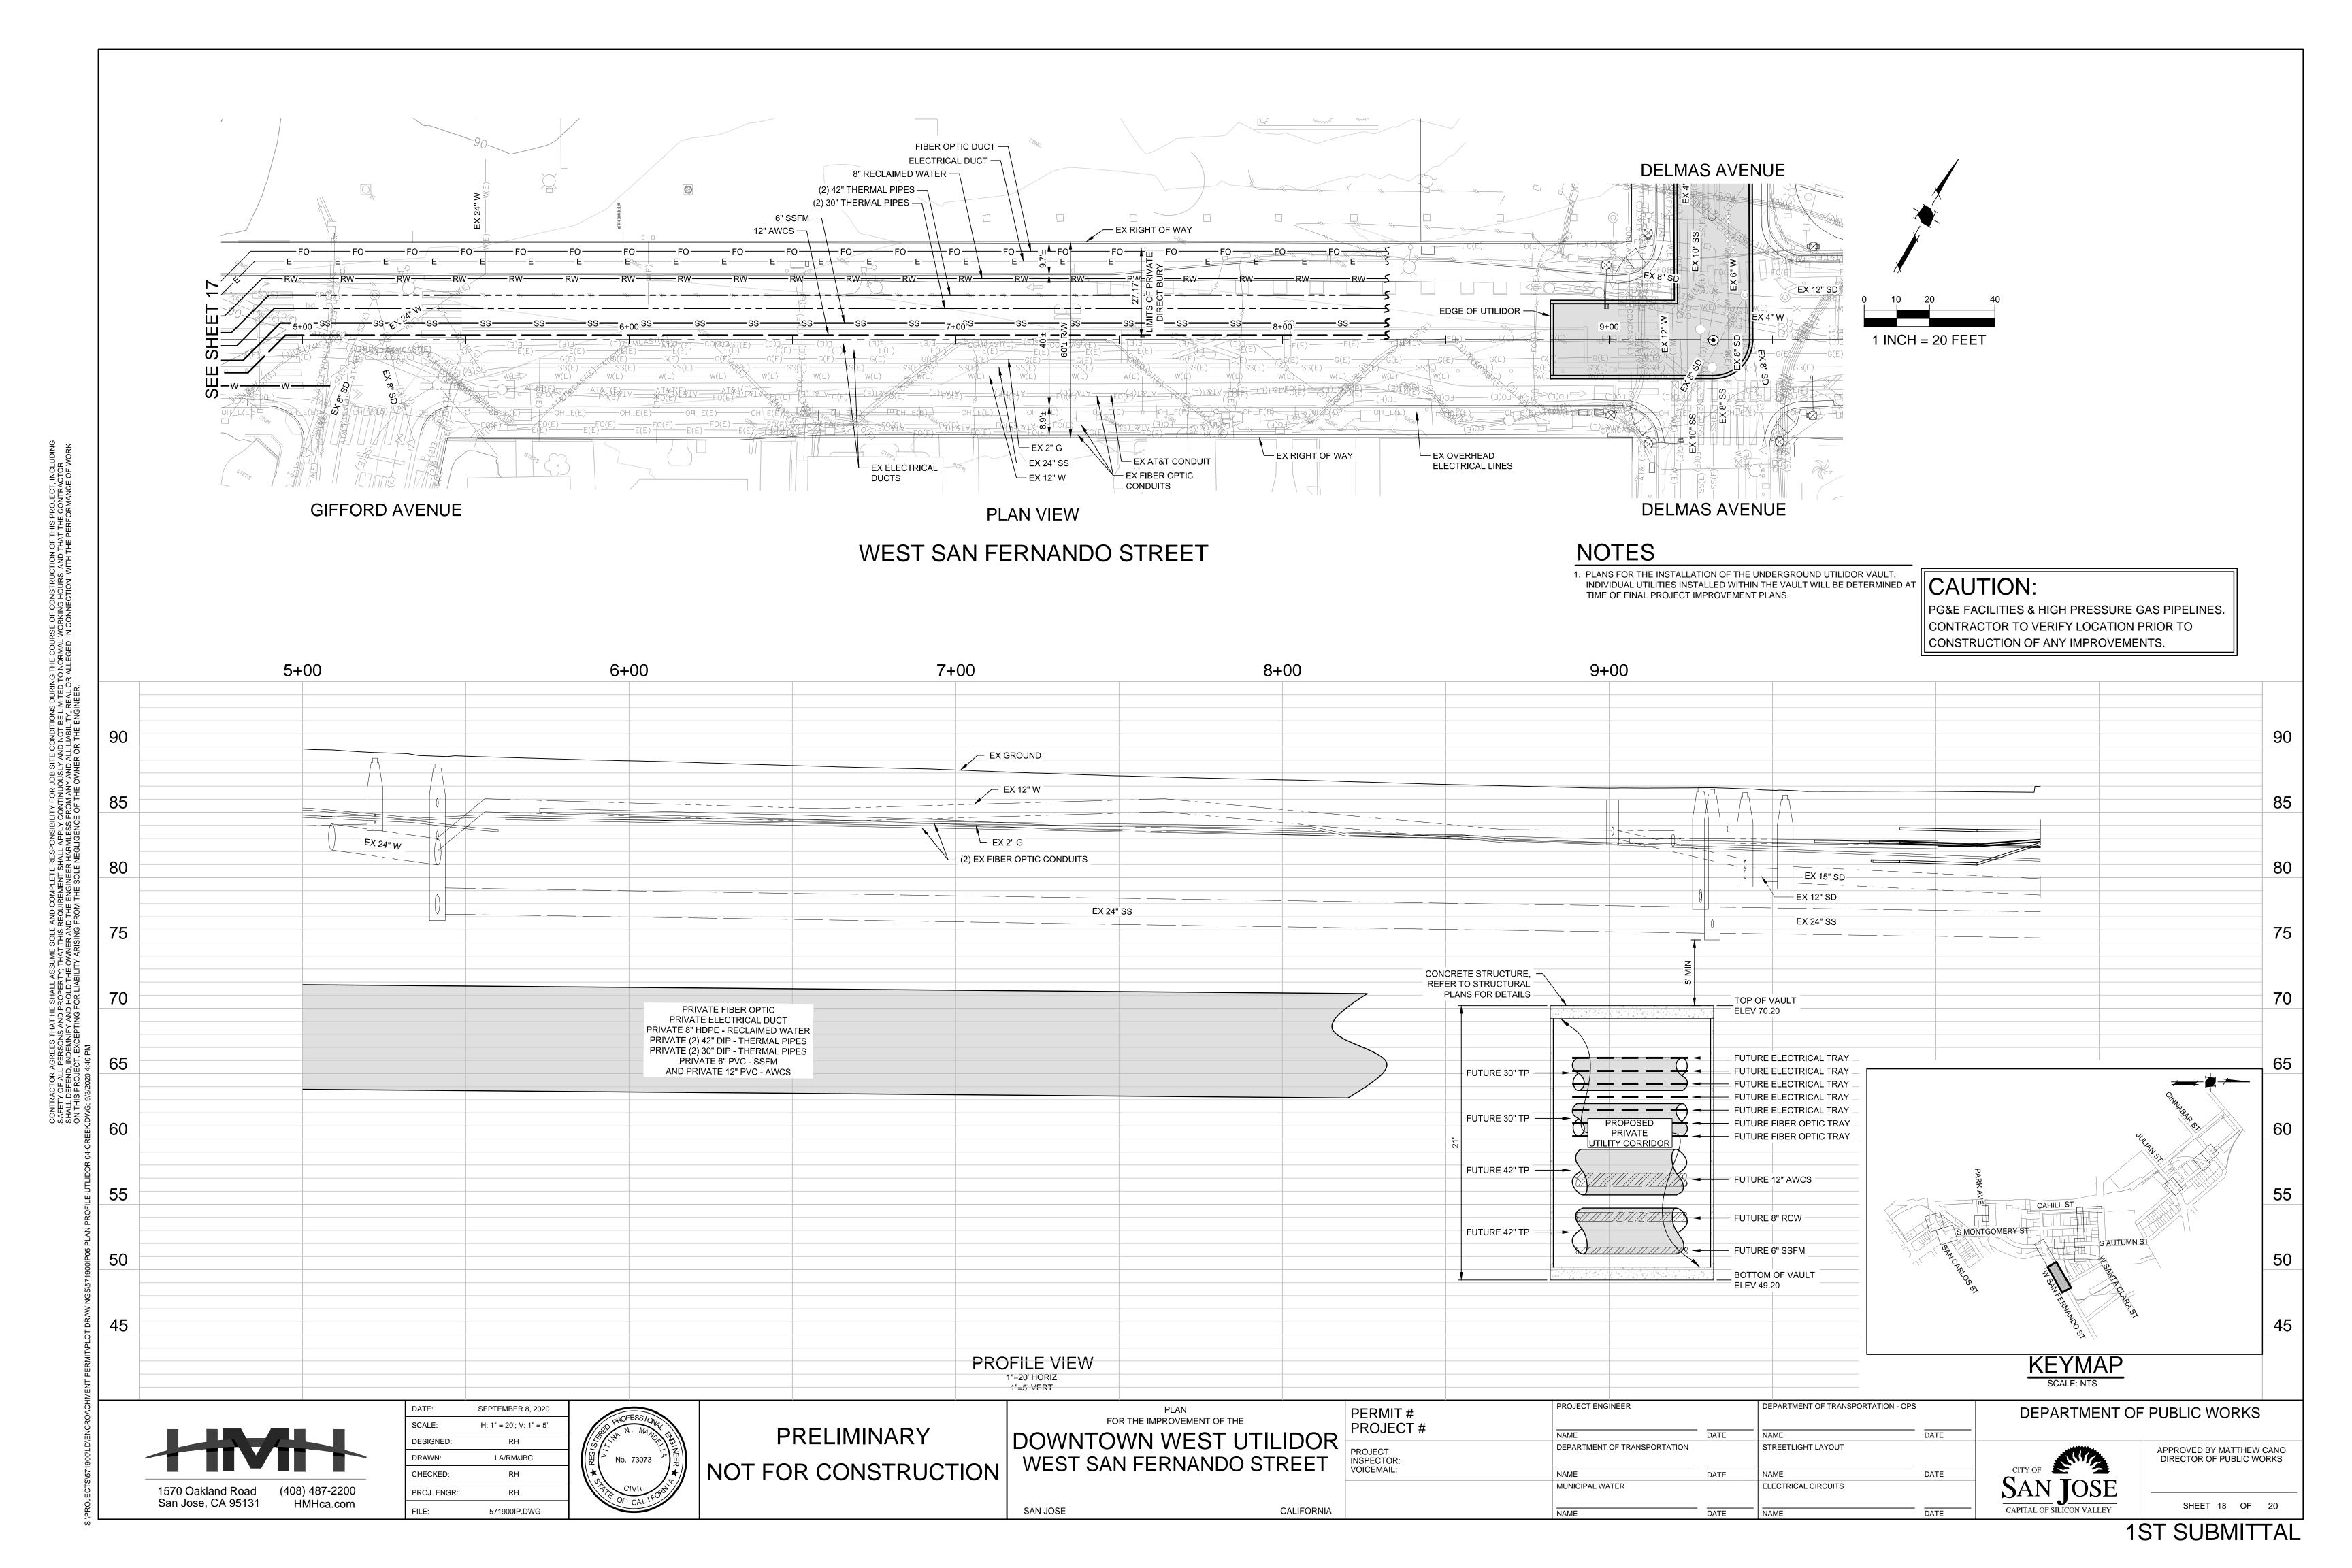

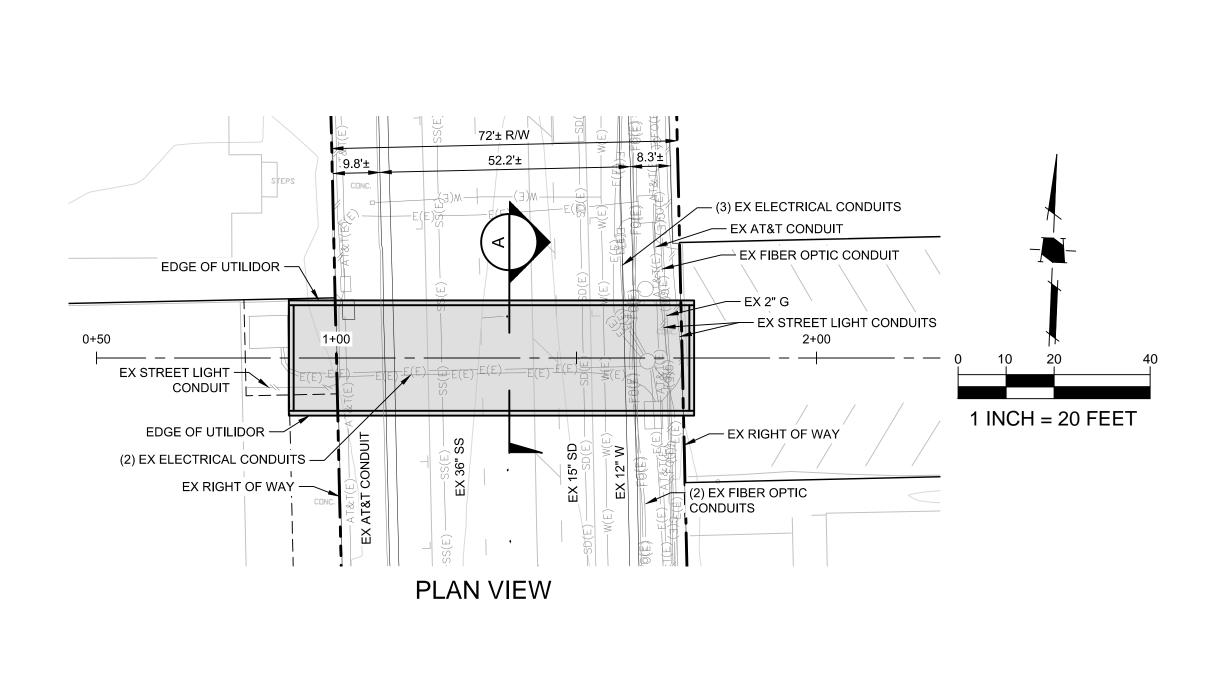

SOUTH AUTUMN STREET

NOTES

1. PLANS FOR THE INSTALLATION OF THE UNDERGROUND UTILIDOR VAULT. INDIVIDUAL UTILITIES INSTALLED WITHIN THE VAULT WILL BE DETERMINED AT TIME OF FINAL PROJECT IMPROVEMENT PLANS.

CAUTION:

PG&E FACILITIES & HIGH PRESSURE GAS PIPELINES. CONTRACTOR TO VERIFY LOCATION PRIOR TO

